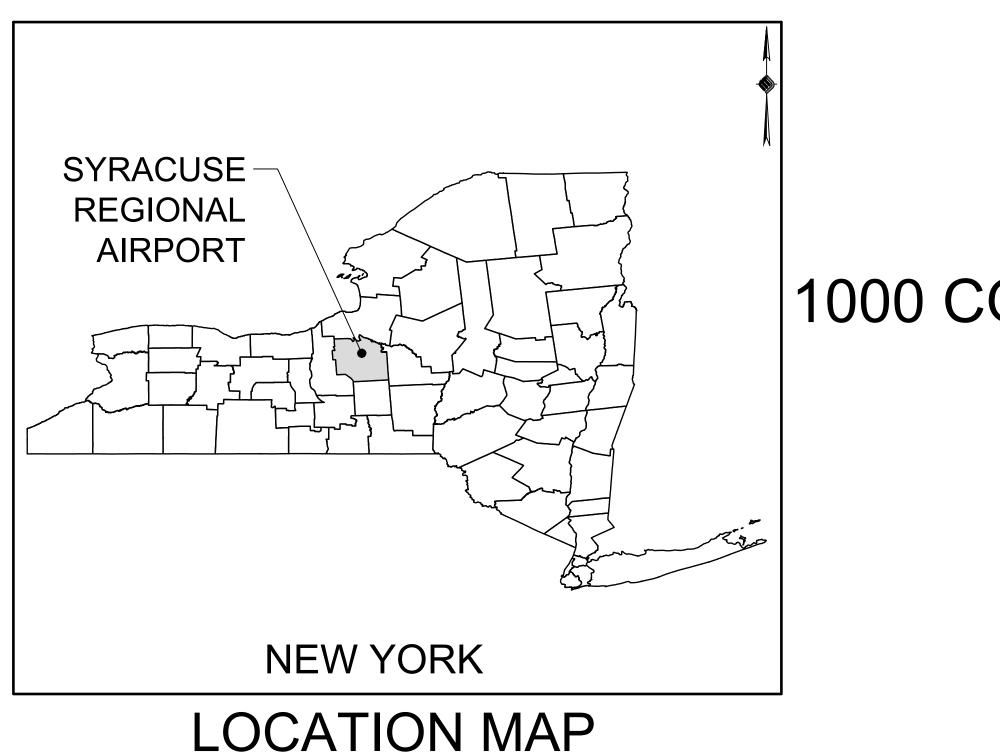
SYRACUSE HANCOCK INTERNATIONAL AIRPORT SURFACE PARKING LOT EXPANSIONS - LOT #3 DESIGN



PREPARED FOR:

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SHEET	SHEET DRAWING NUMBER SHEET TITLE				
		COVER SHEET			
1	GN-1	GENERAL NOTES & QUANTITIES TABLE			
2	EX-1	EXISTING CONDITIONS & DEMOLITION PLAN			
3	MPT-1	MAINTENANCE & PROTECTION OF TRAFFIC PLAN			
4	CS-1	CONSTRUCTION SAFETY & PHASING PLAN			
5	SP-1	SITE LAYOUT PLAN			
6	SS-1	SIGNING & STRIPING PLAN			
7	UT-1	UTILITY, POWER, COMMUNICATIONS, & CONTROL PLAN			
8	LT-1	LIGHTING PHOTOMETRICS PLAN			
9	GR-1	GRADING, DRAINAGE, EROSION & SEDIMENT CONTROL PLAN			
10	GR-2	EROSION & SEDIMENT CONTROL NOTES			
11	DT-1	MISCELLANEOUS DETAILS			
12	DT-2	MISCELLANEOUS DETAILS			
13	DT-3	MISCELLANEOUS DETAILS			

PREPARED BY:

FINAL PLANS AUGUST 2022

1000 COLONEL EILEEN COLLINS BOULEVARD COUNTY OF ONONDAGA SYRACUSE, NEW YORK 13212



SYRACUSE REGIONAL AIRPORT AUTHORITY 1000 COLONEL EILEEN COLLINS BOULEVARD SYRACUSE, NEW YORK 13212 (315) 454-3263 WWW.SYRAIRPORT.ORG



MJ PROJECT NO.: 18831.02



VICINITY MAP

ADAM J. FROSINO

PE_NO

088870

BID SET

PE_DATE

AUGUST 2022

IT IS A VIOLATION OF THE LAW FOR ANY PERSON, UNLESS ACTING UNDER THE DIRECTION OF A LICENSED PROFESSIONAL ENGINEER, ARCHITECT, LANDSCAPE ARCHITECT, OR LAND SURVEYOR, TO ALTER AN ITEM IN ANY WAY. IF AN ITEM BEARING THE STAMP OF A LICENSED PROFESSIONAL IS ALTERED, THE ALTERING ENGINEER, ARCHITECT, LANDSCAPE ARCHITECT, OR LAND SURVEYOR SHALL STAMP THE DOCUMENT AND INCLUDE THE NOTATION "ALTERED BY" FOLLOWED BY THEIR SIGNATURE, THE DATE OF SUCH ALTERATION, AND A SPECIFIC DESCRIPTION OF THE ALTERATION.

_			2		
	GE	NERAL NOTES:		S	EQUENCI
	1.	& LAND SURVEYORS, PLLC, DATED FROM JUN	BERTINE AND CURRIER, ARCHITECTS, ENGINEERS IE 13, 2022 THROUGH JUNE 15, 2022. MCFARLAND RACY OF THEIR LOCATION AND/OR COMPLETENES VERIFY THE LOCATION AND EXTENT OF ALL	5 58.	HOLD A CONTRA TO LANE HAVE A COMMEI
•	2.	ACTIVITIES IN THEIR VICINITY. THE CONTRACTION STAKED BEFORE STARTING WORK BY CALLING THE CONTRACTOR SHALL PERFORM ALL WOR	TOR SHALL HAVE ALL EXISTING UTILITIES FIELD G 1-800-962-7962. RK IN COMPLIANCE WITH TITLE 29 OF FEDERAL		APPROP GP-0-20- PREPAR
	3.		TH REGULATIONS FOR CONSTRUCTION (OSHA). PRIVATE DRIVES SHALL BE KEPT CLEAN OF MUD,		CONSTR DRAWIN
		DEBRIS ETC. AT ALL TIMES. ALL CATCH BASIN CLEANED PRIOR TO ACCEPTANCE BY THE AIR	S AND STORM SEWER MANHOLES SHALL BE		INSTALL DRAWIN
	4.	THE CONTRACTOR SHALL CONSULT THE DES PLANS.	IGN ENGINEER BEFORE DEVIATING FROM THESE	5.	CONSUL INITIAL F TO COM
	5.		MUST LAY THE TRENCH SIDE SLOPES BACK TO A VIDE SHEETING AND BRACING. THE MEANS AND SIONAL ENGINEER.		BEGIN C AREAS V
	6.		OM THE SITE SHALL BE PLACED AT A LOCATION ARTMENT OF ENVIRONMENTAL CONSERVATION.	7.	STRIP AI SEED AN
	7.		S TO MAINTAIN A MINIMUM OF 2' OF COVER OVER S AND 4' OF COVER OVER ALL SANITARY PIPES	8.	COMMEI REASON SITE GR
B	8.		E. WATER VALVES, CATCH BASIN FRAMES AND DJECT LIMITS SHALL BE ADJUSTED TO FINISHED		STABILIZ WITHIN 7
	9.	AREAS DISTURBED OR DAMAGED AS PART OF OUTSIDE OF THE PRIMARY WORK AREA SHAL TO THE SATISFACTION OF THE OWNER'S REP	L BE RESTORED, AT THE CONTRACTORS EXPENS		CONSTR PHASED TREATE
	10.	UNLESS COVERED BY THE CONTRACT SPECIF WORK SHALL CONFORM TO THE LATEST NEW STANDARD SPECIFICATIONS AND ANY SUBSE	YORK STATE DEPARTMENT OF TRANSPORTATIO		I. BEGIN U WITH SE
	11.		O SECURE ALL PERMITS AND PROVIDE ALL BOND		2. CONSTR ON THE
	10	ELECTRICAL AND SITE CONSTRUCTION.			3. INSTALL 4. AS LANE
	12.	AND/OR CERTIFICATIONS REQUIRED BY CODE SHALL BE COMPLETED PRIOR TO ANNOUNCE	OR OBTAINING ALL NECESSARY INSPECTIONS E AND/OR UTILITY SERVICE COMPANIES. THIS D POSSESSION AND THE FINAL CONNECTION OF		5. FINALIZE
	13.		ALONG WITH SECURING THE WORK AREA SHALL		6. INSTALL
c	14.	BE THE RESPONSIBILITY OF THE CONTRACTOR THE CONTRACTOR SHALL LOCATE, SAFEGUA MONUMENTS AND ROW MONUMENTS IN THE	RD AND PRESERVE ALL SURVEY CONTROL	17	7. CARRY (EXCEED DISTURE
	15.			18	3. A QUALI PERMAN GERMIN TEMPOF
	16.	CONSTRUCTION. SHOULD THE CONTRACTOR RELATIVE TO THE SPECIFICATION OR APPLICA RESPONSIBILITY TO NOTIFY THE OWNERS RE CONSTRUCTION. FAILURE BY THE CONTRACT	JECT WORK SCOPE PRIOR TO THE INITIATION OF FIND A CONFLICT WITH THE DOCUMENTS ABLE CODES, IT IS THE CONTRACTORS P. IN WRITING PRIOR TO THE START OF OR TO NOTIFY THE OWNERS REP. SHALL SIBILITY BY THE CONTRACTOR TO COMPLETE THI	E SIGNS	
	WC	RK ZONE TRAFFIC CONTROL		1. THE LOCATIONS	
	GE	NERAL		PLANS AND DET CONSIDERATION THE ENGINEER.	NS. THE FIN
D	2. 3.	ALL WORK ZONE TRAFFIC CONTROL (WZTC) S NYSDOT STANDARD SHEETS SECTION 619. TH WZTC PLAN FOR APPROVAL BY THE AIRPORT THE TYPICAL DETAILS DEPICTED ON THE NYS AND IN THE MUTCD, REFLECT THE MINIMUM R THE CONTRACTOR MUST SUBMIT TO THE ENG	E CONTRACTOR SHALL SUBMIT A PRIOR TO ANY IMPLEMENTATION. DOT SECTION 619 STANDARD SHEETS EQUIREMENTS. GINEER, IN WRITING, PROPOSED	 ANY EXISTING S TEMPORARY TR STORED OR RES SIGNS SHALL BE UNLESS OTHER SIGNS AT OR NE 	AFFIC CON SET, AS API E RESTORE WISE REPL EAR INTERS
		REVISIONS TO THE TRAFFIC CONTROL PLAN F AIRPORT FIVE (5) WORK DAYS PRIOR TO THE I PROPOSED REVISIONS. THE CONTRACTOR SHALL PROVIDE THE ENGI ADDRESSES, AND TELEPHONE NUMBERS OF S SECURE LABOR, MATERIALS, AND EQUIPMENT NORMAL WORKING HOURS. THE ENGINEER W	PLANNED IMPLEMENTATION OF SUCH NEER, IN WRITING, WITH THE NAMES, STAFF WHO ARE AUTHORIZED TO TFOR EMERGENCY REPAIRS OUTSIDE	 OBSTRUCT A MO 4. ALL WARNING A MULTI-LANE RAN REDUCE THE TR SIDE OF THE AC ENGINEER. 5. THE DIMENSION 	ND REGUL MPS, AND C RAVEL LANE TIVE TRAV
	۵٢	TO THE AIRPORT.		MUTCD. ANY CH REGIONAL DIRE 6. NYR9-12 MAY BE	CTOR OR B
	1.	THE CONTRACTOR SHALL MAINTAIN A MINIM		BARRIER/SHADO	
	2.	BETWEEN CONSTRUCTION OPERATIONS ON A UNLESS OTHERWISE APPROVED BY THE ENG WHEN TWO OR MORE AREAS ARE ADJACENT	SINEER.	1. BARRIER AND SH TITLED "WORK Z	
		PROXIMITY, THE CONTRACTOR SHALL ENSUR AND THAT LANE CONTINUITY IS MAINTAINED	RE THERE ARE NO CONFLICTING SIGNS THROUGHOUT ALL WORK AREAS.	2. NO WORK ACTIV BETWEEN THE B AHEAD DISTANC	'ITY, EQUIP BARRIER OF E).
E		ANE WIDTHS UNLESS AUTHORIZED BY THE ENGINEER, TH		3. THE CONTRACTO CONJUNCTION V THE UNIT BID PR	VITH POLIC
	1.	ZONE TRAVEL LANES SHALL BE AS FOLLOW 11'. THE MINIMUM LANE WIDTH FOR ALL OTH THE CONTRACTOR SHALL PROVIDE A WRITT	S: FREEWAYS AND/OR EXPRESSWAYS IS IER TYPES OF ROADWAYS IS 10'.	CHANNELIZING D	

11'. THE MINIMUM LANE WIDTH FOR ALL OTHER TYPES OF ROADWAYS IS 10'. THE CONTRACTOR SHALL PROVIDE A WRITTEN NOTICE TO THE ENGINEER, A MINIMUM OF 21 CALENDAR DAYS IN ADVANCE OF PERFORMING ANY WORK THAT RESULTS IN THE REDUCED WIDTH OF AN EXISTING ROADWAY.

LANE CLOSURES

1

1. THE AIRPORT RETAINS THE RIGHT TO CANCEL ANY WORK OPERATIONS INCLUDING LANE CLOSURE AND/OR TOTAL ROAD CLOSURES THAT WOULD BE AFFECTED BY UNFORESEEN MAJOR EVENTS THAT MAY CREATE TRAFFIC DELAYS SEVEN (7)

CE OF CONSTRUCTION

- A PRE-CONSTRUCTION MEETING RACTORS & SUB-CONTRACTORS, AND REPRESENTATIVES OF THE SYRACUSE AIRPORT PRIOR ND DISTURBING ACTIVITIES.
- INGS.
- INGS.
- MMENCEMENT OF GROUND DISTURBANCE.
- WHERE EARTHWORK WILL BE PERFORMED.
- AND MULCH PER PLANS.
- RADING.
- N 7 DAYS.
- TED BY APPROPRIATE EROSION AND SEDIMENT CONTROL DEVICES.
- IE PLANS.
- FICATIONS.
- ZE PAVEMENT SUB-GRADE PREPARATION.
- RBED AREAS.
- DRARY EROSION AND SEDIMENT CONTROLS.
- SIGNS SHOWN ON THE WORK ZONE TRAFFIC CONTROL BE ADJUSTED BASED ON SIGHT DISTANCE AND OTHER INAL LOCATIONS OF SIGNS ARE SUBJECT TO APPROVAL OF
- CLUDING OVERHEAD SIGNS, WHICH CONFLICT WITH THE ONTROL SIGN LAYOUT SHALL BE COVERED, REMOVED, PPROVED BY THE ENGINEER. ALL APPROPRIATE EXISTING RED TO THEIR ORIGINAL CONDITION AND/OR LOCATION PLACED IN THIS CONTRACT.
- RSECTIONS SHALL BE PLACED SO THAT THEY DO NOT 'S LINE OF SIGHT.
- JLATORY SIGNS SHALL BE POSTED ON BOTH SIDES OF ONE-WAY STREETS. IN CASES WHERE LANE RESTRICTIONS NE TO ONE LANE, SIGNS SHALL BE POSTED ON THE RIGHT VEL LANE, UNLESS OTHERWISE AUTHORIZED BY THE
- RK ZONE TRAFFIC CONTROL SIGNS ARE DESCRIBED IN THE TO THE DIMENSIONS SHALL BE APPROVED BY THE BY HIS/HER DESIGNEE I PLACE OF NYR9-11.

CLES

- EHICLES SHALL BE REQUIRED AS PER STANDARD SHEET
- FFIC CONTROL LEGENDS AND NOTES". IPMENT, VEHICLES AND/OR MATERIALS SHALL BE LOCATED
- BE REQUIRED TO PROVIDE A BARRIER VEHICLE IN
- ICE PRESENCE IN THE WORK ZONE, TO BE INCLUDED IN BASIC WORK ZONE TRAFFIC CONTROL.

WHERE POSSIBLE ALL CHANNELIZING AND GUIDING DEVICES ARE TO BE PLACED SO AS TO PROVIDE A MINIMUM 2' LATERAL CLEARANCE TO THE TRAVELED WAY.

PUBLIC ACCESS

PROPERTY OWNERS WHOSE DRIVEWAYS WILL BE MADE INACCESSIBLE SHALL BE 1. NOTIFIED BY THE CONTRACTOR AT LEAST 24 HOURS PRIOR TO RESTRICTING USE OF THE DRIVEWAY. FOR MULTIPLE ACCESS PROPERTIES, AT LEAST ONE DRIVEWAY

2

3

G WITH PROJECT MANAGER,	OPERATOR'S ENGINEER,	

A QUALIFIED PROFESSIONAL CONDUCT AN ASSESSMENT OF THE SITE PRIOR TO THE ENCEMENT OF CONSTRUCTION AND CERTIFY IN AN INSPECTION REPORT THAT THE OPRIATE EROSION AND SEDIMENT CONTROLS DESCRIBED IN THE SWPPP AS REQUIRED BY THE 0-001 HAVE BEEN ADEQUATELY INSTALLED OR IMPLEMENTED TO ENSURE OVERALL REDNESS OF THE SITE FOR THE COMMENCEMENT OF CONSTRUCTION.

FRUCT TEMPORARY STABILIZED CONSTRUCTION ENTRANCE AT LOCATION SHOWN ON THE

LL PERIMETER CONTROLS AND INLET PROTECTION AT THE LOCATIONS SHOWN ON THE

JLT A QUALIFIED PROFESSIONAL TO PERFORM A SITE INSPECTION AND VERIFY THAT THE PHASE OF EROSION CONTROL DEVICES HAVE BEEN INSTALLED PER THE DRAWINGS PRIOR

CLEARING AND GRUBBING OPERATIONS. CLEARING AND GRUBBING SHALL ONLY BE DONE IN

AND STOCKPILE TOPSOIL, INSTALL PERIMETER EROSION CONTROL AROUND STOCKPILES,

ENCE EARTHWORK CUTS AND FILLS. WORK SHALL BE PROGRESSED TO ALLOW A DNABLE TRANSFER OF CUT AND FILL FOR ROUGH GRADING AND EARTH MOVING FOR BULK

LIZE ALL AREAS IDLE IN EXCESS OF 7 DAYS IN WHICH CONSTRUCTION WILL NOT COMMENCE

TTHE EROSION AND SEDIMENT CONTROL PRACTICES AS REQUIRED FOR CONTINUING FRUCTION AS SHOWN ON THE EROSION & SEDIMENT CONTROL PLAN. THIS SHALL BE A ED ADJUSTMENT IN ORDER TO ENSURE THAT RUNOFF FROM ALL DISTURBED AREAS IS

UTILITY INSTALLATION AND BACKFILL. UTILITY INSTALLATION AREA SHALL BE STABILIZED SEED AND MULCH PROGRESSIVELY AT THE END OF EACH WORK DAY.

TRUCT CULVERTS, CATCH BASINS, AREA INLETS AND STORM SEWER MANHOLES, AS SHOWN

L INLET/OUTLET PROTECTION PROGRESSIVELY AS THE STORM SEWER IS INSTALLED.

NDSCAPED AREAS ARE BROUGHT TO GRADE, STABILIZE WITH TOPSOIL, SEED AND MULCH PER

LL SUBBASE AND ASPHALT MATERIAL AS REQUIRED FOR PAVEMENT.

OUT ALL FINAL GRADING, STABILIZE SLOPES GREATER THAN 3H:1V WITH HEIGHTS DING 5 FEET WITH EROSION CONTROL MATTING/BLANKETS, AND SEED AND MULCH ALL

LIFIED PROFESSIONAL SHALL PERFORM A SITE ASSESSMENT TO CONFIRM THAT ALL ANENT STORMWATER DEVICES HAVE BEEN INSTALLED PER PLANS AND 80% UNIFORM INATION/STABILIZATION HAS BEEN ACHIEVED PRIOR TO THE REMOVAL OF ALL REMAINING

Bid Item	Description Of Item	Unit	Quantity
203.02	UNCLASSIFIED EXCAVATION AND DISPOSAL	CY	800
203.03	EMBANKMENT IN PLACE	CY	1685
207.21	GEOTEXTILE SEPARATION FABRIC	SY	3460
209	EROSION AND SEDIMENT CONTROL	LS	1
209.13	SILT FENCE	LF	970
304.12	SUBBASE COURSE, TYPE 2	CY	1160
402.0982	TYPE 9.5 TOP COURSE, HMA, 80 SERIES COMPACTION	TON	290
402.1982	TYPE 19 BINDER COURSE, HMA, 80 SERIES COMPACTION	TON	470
407.0102	DILUTED TACK COAT	GAL	510
603.1714	15" METAL END SECTION	EA	2
603.9812	SICPP CULVERT AND STORMDRAIN 12 INCH DIAMETER (WITH BACKFILL)	LF	260
619.01	WORK ZONE TRAFFIC CONTROL	LS	1
625.01	SURVEYING OPERATIONS	LS	1
660.0404	FURNISH AND INSTALL PVC UTILITY CONDUIT - 4 INCH	LF	355.71
685.02	YELLOW EPOXY REFLECTORIZED PAVEMENT STRIPES - 15 MIL	LF	3400
	SIGNAGE	LS	16
	SIGN POSTS	EA	16
	LIGHT POLES P3 (FIXTURES, POLES AND FOUNDATIONS)	EA	3
	ELECTRICAL/COMMUNICATIONS	LS	1
	STORMWATER TREATMENT FACILITIES	LS	1
610.1602	ESTABLISH TURF	SY	11130
610.1401	TOPSOIL - REUSE ON SITE MATERIAL	CY	900
	MOBILIZATION	LS	1

OR SHADOW VEHICLE AND THE ACTIVE WORK AREA (ROLL

4

SURVEYOR'S STANDARD NOTES: 1. UNAUTHORIZED ALTERATION OR ADDITION TO A SURVEY MAP BEARING A LICENSED LAND SURVEYOR'S SEAL IS A VIOLATION OF SECTION 7209, SUB-DIVISION 2, OF THE NEW YORK STATE EDUCATION LAW.

2. ONLY BOUNDARY SURVEY MAPS WITH THE SURVEYOR'S EMBOSSED SEAL OR RED INK SEAL ARE GENUINE TRUE AND CORRECT COPIES OF THE SURVEYOR'S ORIGINAL WORK AND OPINION.

3. CERTIFICATIONS ON THIS BOUNDARY SURVEY MAP SIGNIFY THAT THE MAP WAS PREPARED IN ACCORDANCE WITH THE CURRENT EXISTING CODE OF PRACTICE FOR LAND SURVEYS ADOPTED BY THE NEW YORK STATE ASSOCIATION OF PROFESSIONAL LAND SURVEYORS, INC. THE CERTIFICATION IS LIMITED TO PERSONS FOR WHOM THE BOUNDARY SURVEY MAP IS PREPARED, TO THE TITLE COMPANY, TO THE GOVERNMENTAL AGENCY, AND TO THE LENDING INSTITUTION LISTED ON THIS BOUNDARY SURVEY MAP.

4. THE CERTIFICATIONS HEREON ARE NOT TRANSFERABLE.

5. THE LOCATION OF UNDERGROUND IMPROVEMENTS OR ENCROACHMENTS ARE NOT ALWAYS

KNOWN AND OFTEN MUST BE ESTIMATED. IF ANY UNDERGROUND IMPROVEMENTS OR ENCROACHMENTS EXIST OR ARE SHOWN, THE IMPROVEMENTS OR ENCROACHMENTS ARE NOT COVERED BY THIS CERTIFICATE.

5

SURVEYOR'S GENERAL NOTES: 1. THE UNDERGROUND UTILITIES AND FEATURES SHOWN HEREON HAVE BEEN LOCATED FROM ABOVE GROUND VISIBLE FEATURES AND OTHER AVAILABLE RECORDS AND THEREFORE THEIR LOCATION SHOULD BE CONSIDERED APPROXIMATE ONLY. OTHER UNDERGROUND UTILITIES AND FEATURES MAY EXIST, EITHER IN SERVICE OR ABANDONED, THAT ARE NOT INDICATED ON THIS SURVEY. DIG SAFELY NEW YORK (UFPO) SHOULD BE CONTACTED PRIOR TO PERFORMING ANY EXCAVATION ACTIVITIES.

2. THE FIELD SURVEY WAS PERFORMED FROM JUNE 13, 2022 THROUGH JUNE 15, 2022.


3. THE HORIZONTAL DATUM FOR THIS SURVEY IS BASED ON NYS CENTRAL ZONE NAD83(2011) (NORTH AMERICAN DATUM 1983/2011).


4. THE VERTICAL DATUM FOR THIS SURVEY IS BASED ON THE NORTH AMERICAN VERTICAL DATUM OF 1988 (NAVD88).


5. ALL HORIZONTAL AND VERTICAL CONTROL IS REFERENCE TO THE PRIMARY AIRPORT CONTROL STATION (PACS) "HANCOCK NE BASE", WITH AN ELEVATION OF 410.83'.

6

8	1	
McFarland Johnson Engineers, Planning & Construction Administration 15 FISHERS ROAD; SUITE 200 PITTSFORD, NEW YORK 14534 P:585-905-0970 F:585-905-0882 Pittsford@mjinc.com PROJECT MILESTONE NO. DATE DESCRIPTION		
NATIONAL AIRPORT LINS BOULEVARD DRK 13212 CEXPANSIONS GN	В	
ENT: YRACUSE HANCOCK INTERNATIONAL AI 1000 COLONEL EILEEN COLLINS BOULEV SYRACUSE, NEW YORK 13212 DJECT: DJECT: SURFACE PARKING LOT EXPANSION LOT #3 DESIGN	c	
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BID SET IT IS A VIOLATION OF LAW FOR ANY PERSON, UNLESS THEY ARE ACTING UNDER THE DIRECT DIRECTION OF A LICENSED PROFESSIONAL ENGINEER, ARCHITECT, LANDSCAPE ARCHITECT, OR LAND SURVEYOR, TO ALTER AN ITEM IN ANY WAY. IF AN ITEM BEARING THE STAMP OF A LICENSED PROFESSIONAL IS ALTERED, THE ALTERING ENGINEER, ARCHITECT, LANDSCAPE ARCHITECT, OR LAND SURVEYOR SHALL STAMP THE DOCUMENT AND INCLUDE THE NOTATION "ALTERED BY" FOLLOWED BY THEIR SIGNATURE, THE DATE OF SUCH ALTERATION, AND A SPECIFIC DESCRIPTION OF THE ALTERATION.	E	
GENERAL NOTES & QUANTITIES TABLE DRAWING NUMBER GN-1 1 OF 13 8		

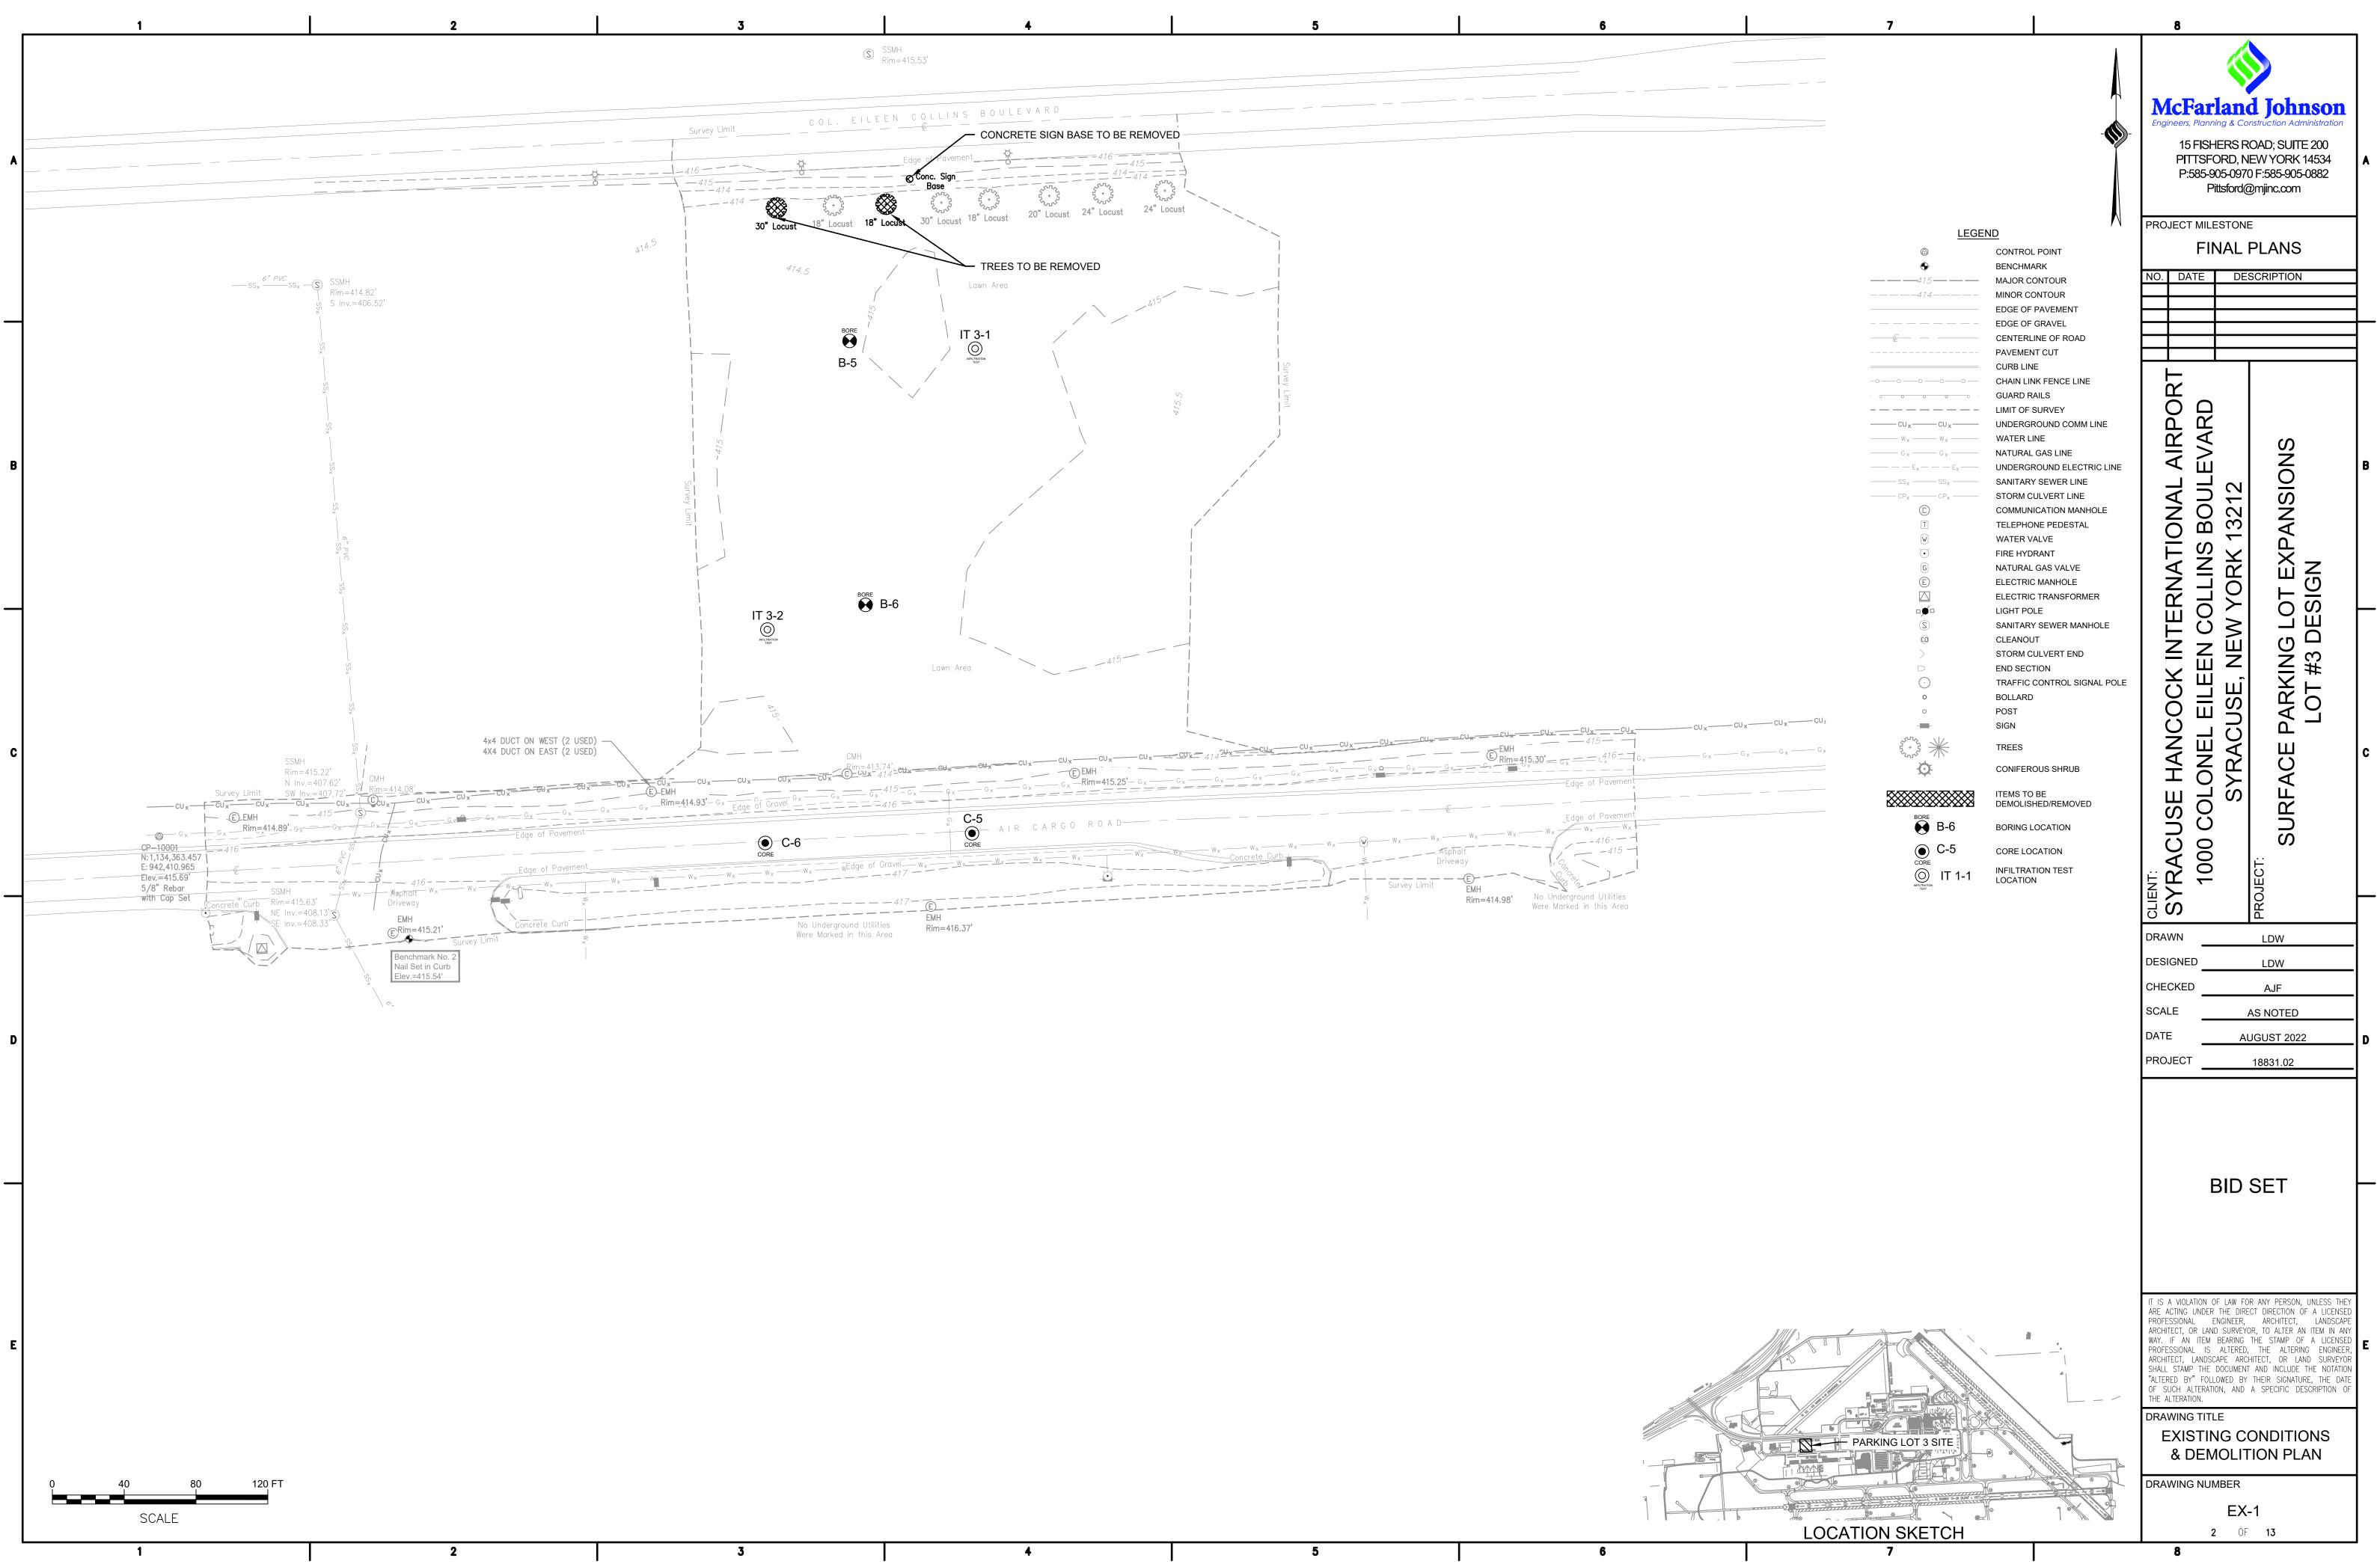

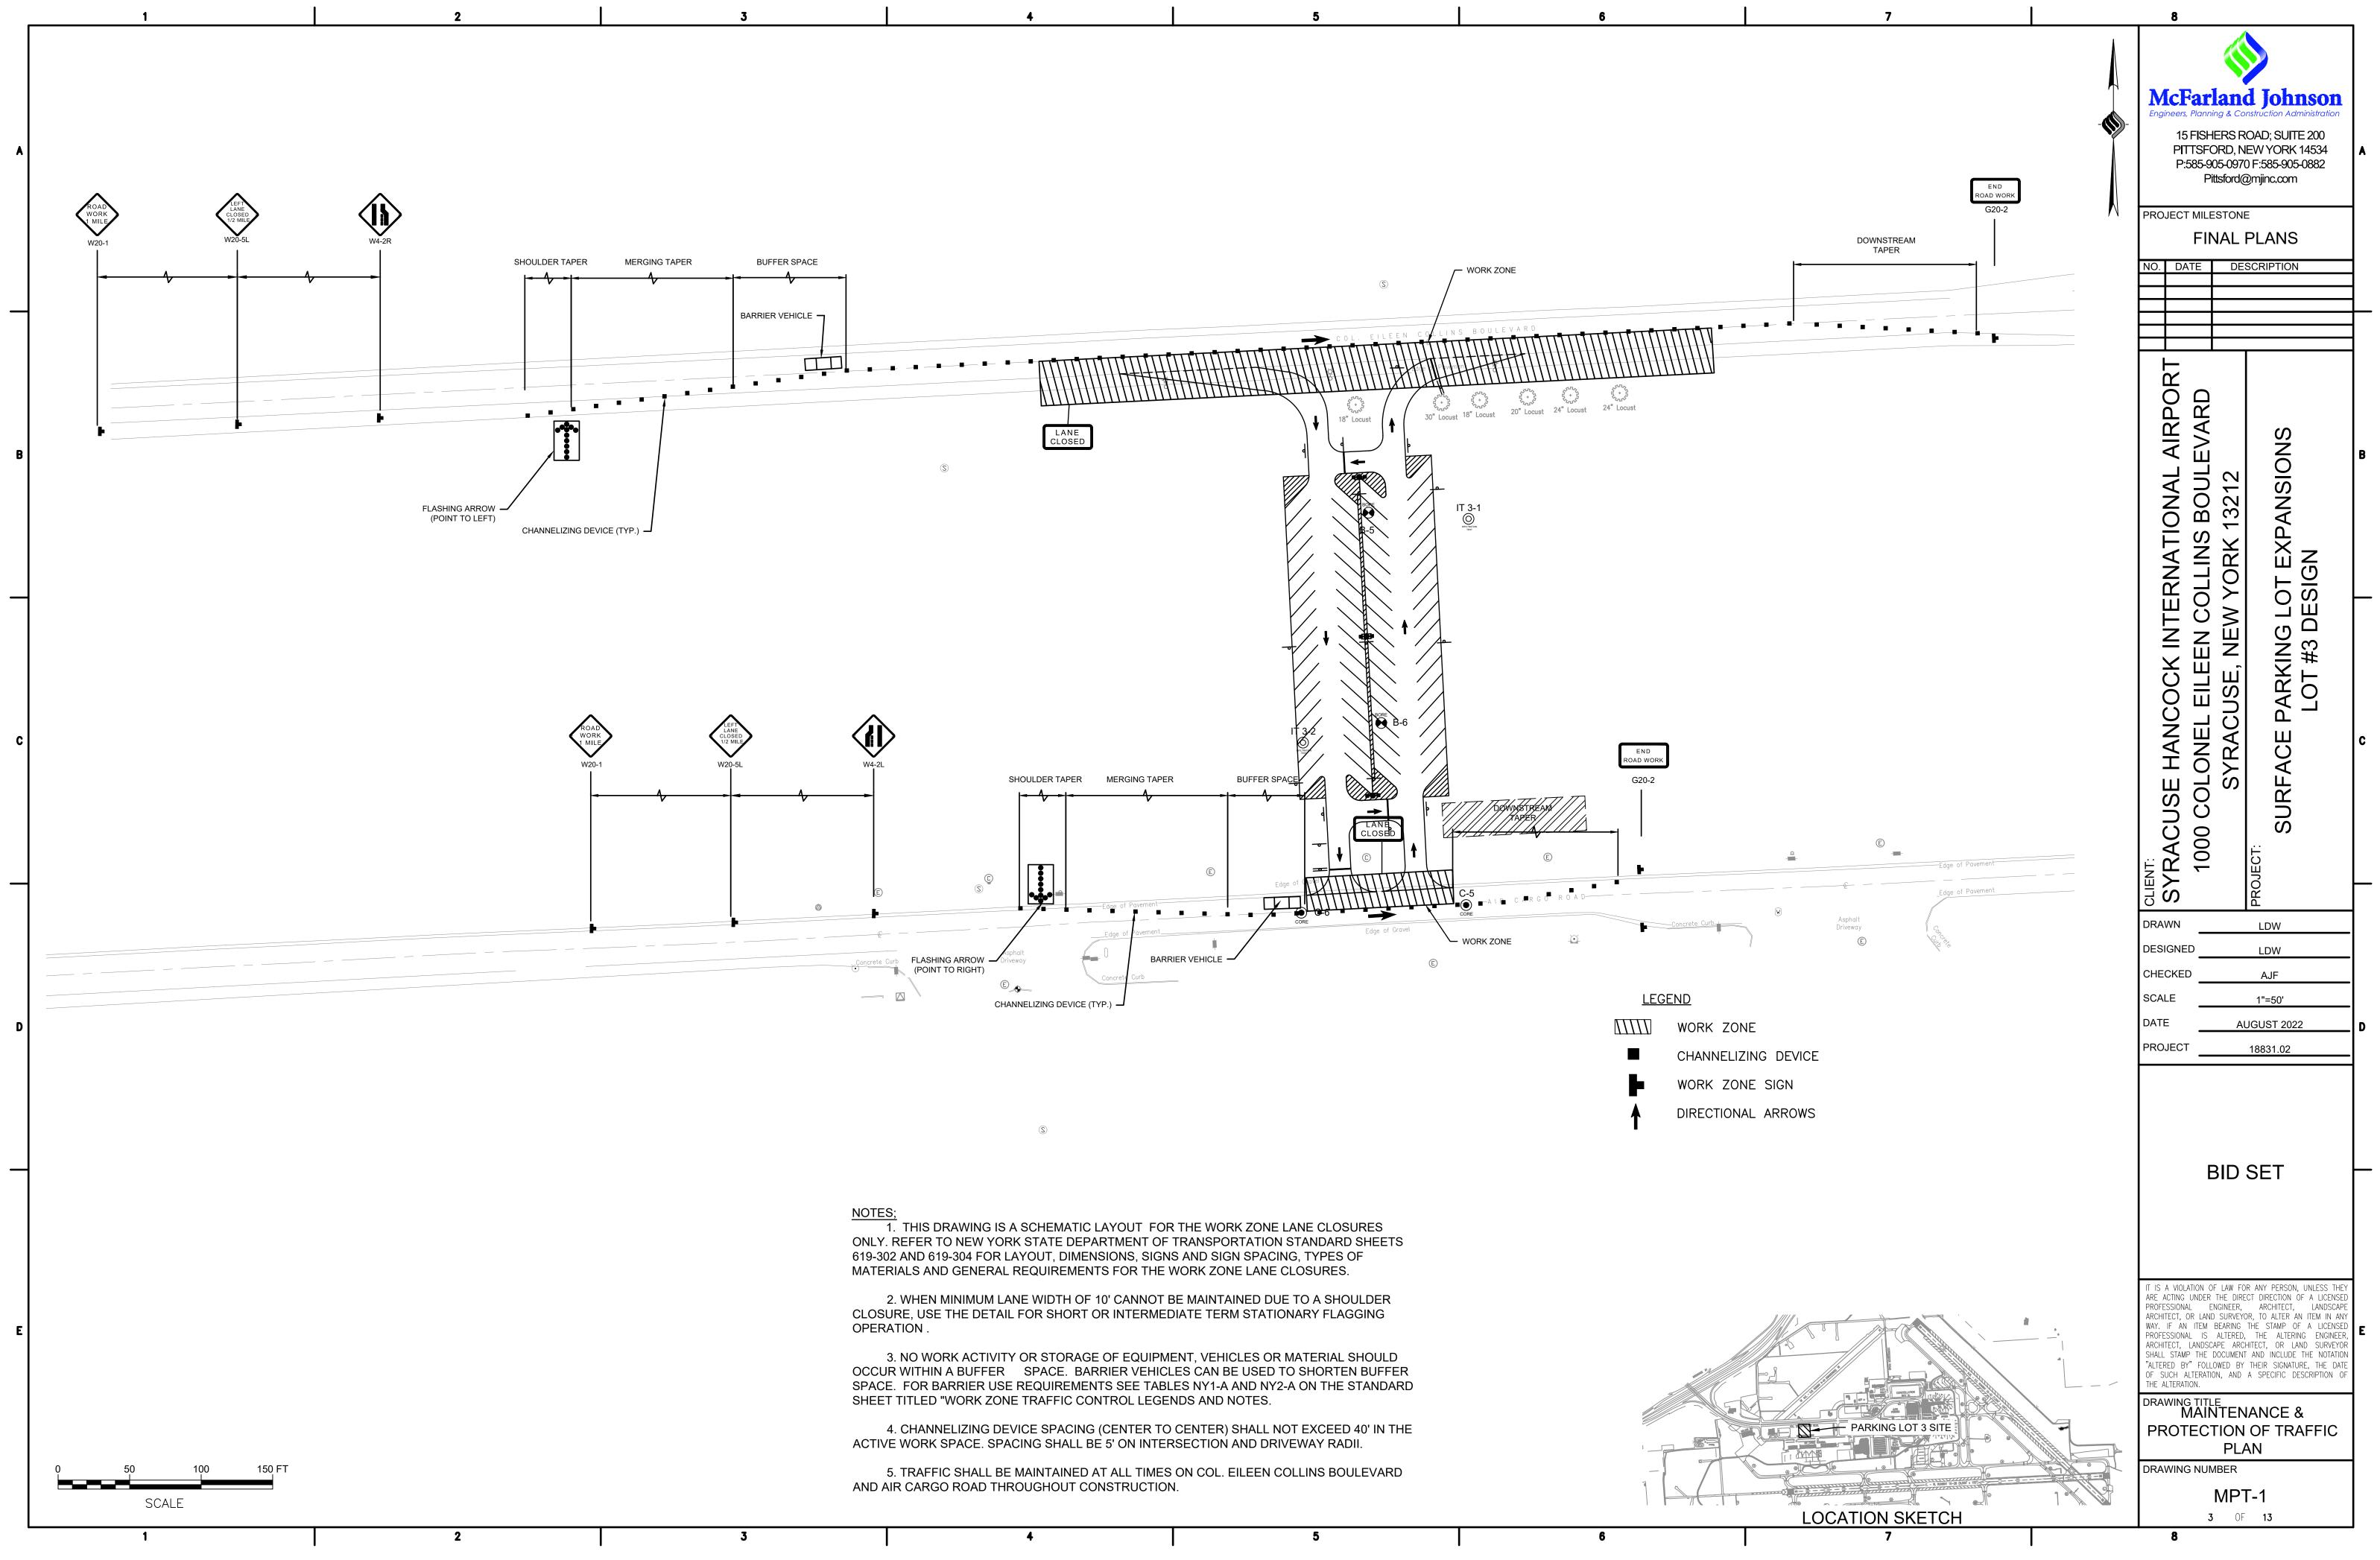

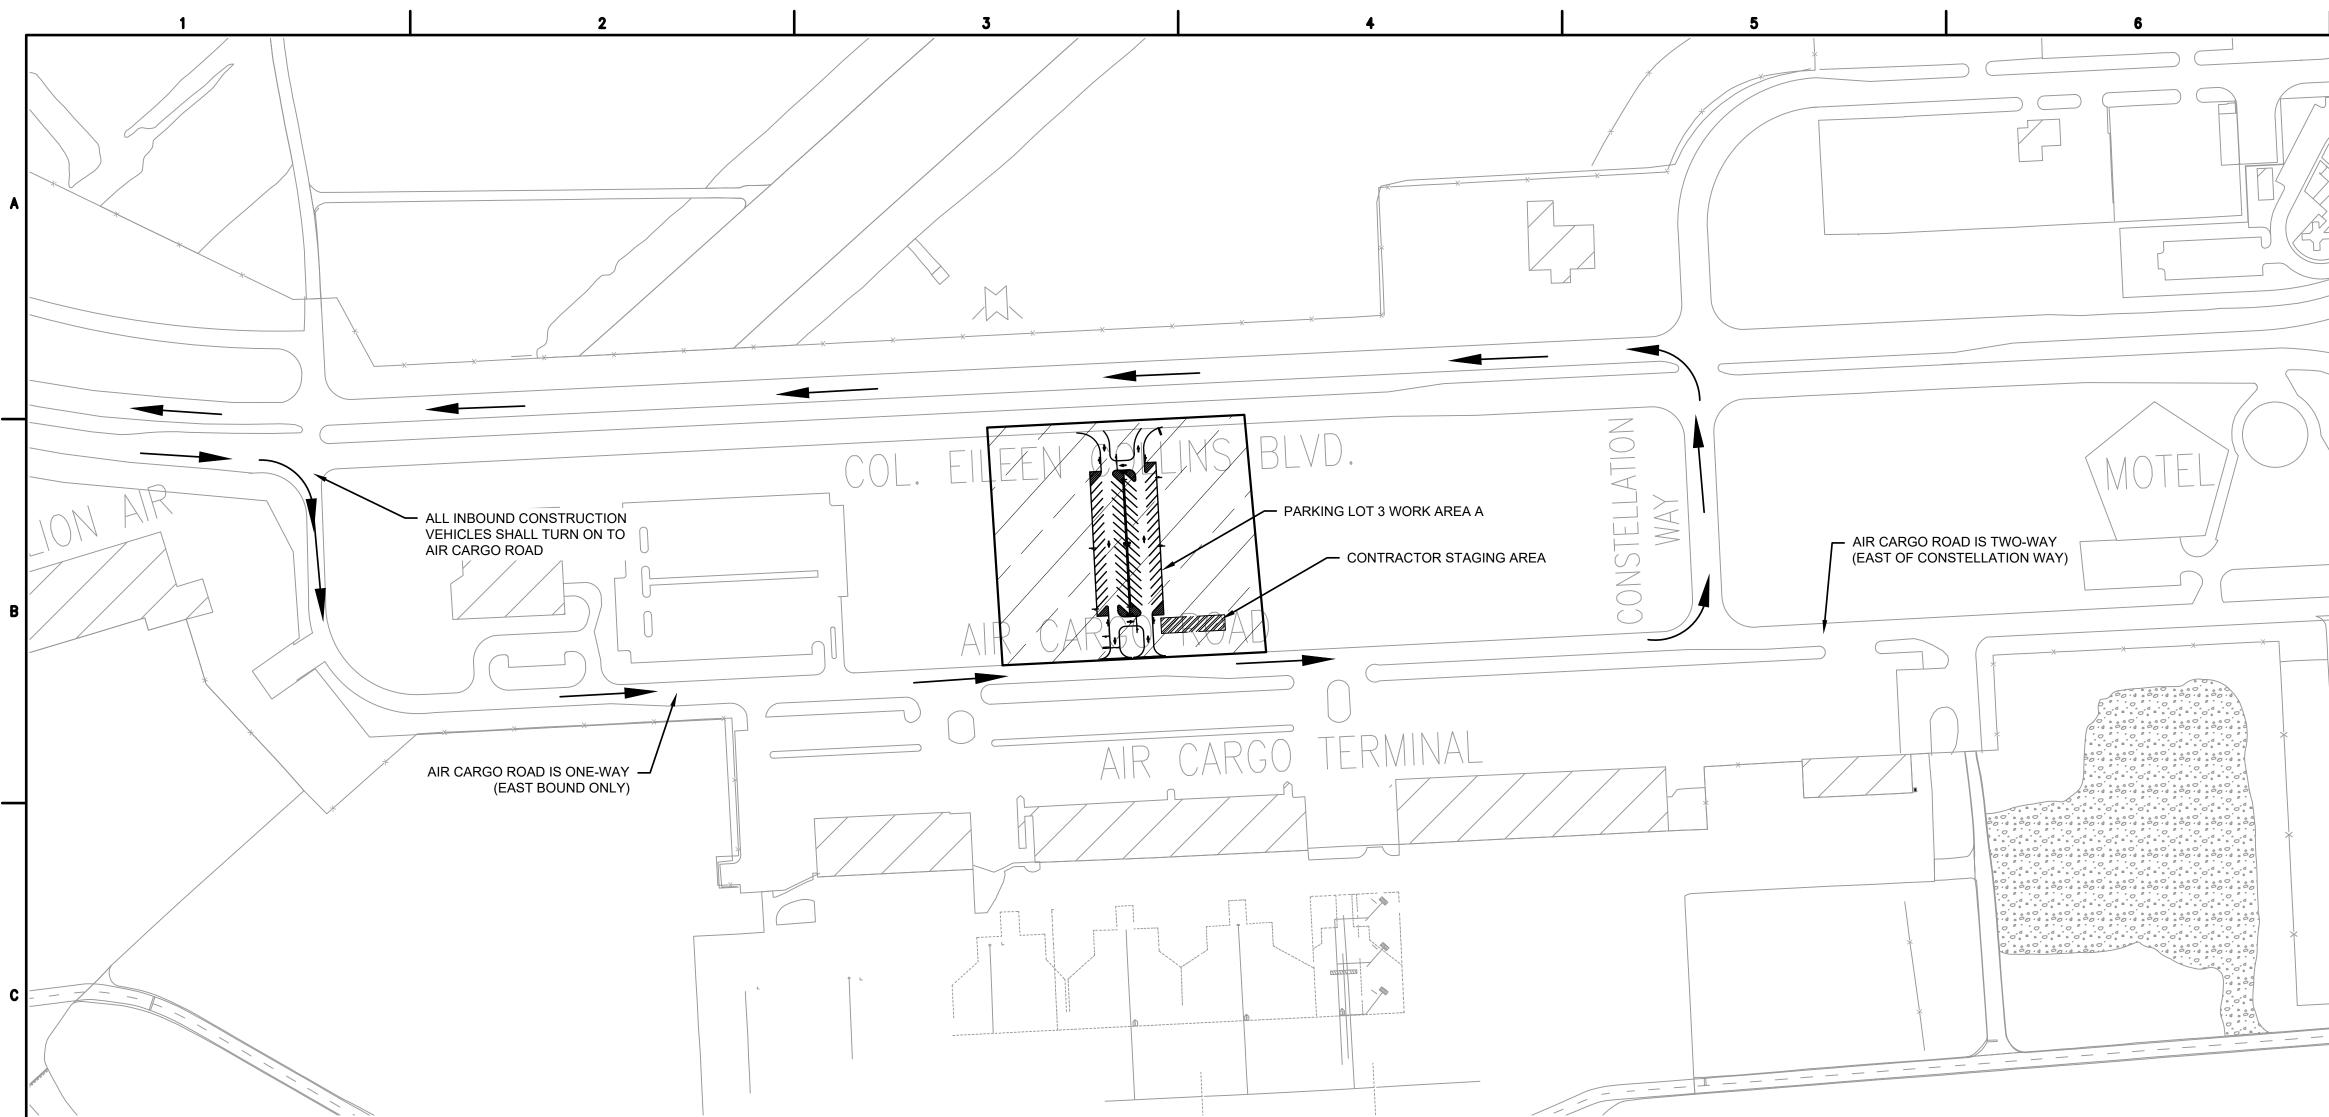

WORK ITEMS/SEQUENCE OF CONSTRUCTION - PHASE 1:

SEQUENCE	WORK ITEM
1.	MOBILIZE AND ESTABLISH CONTRACTOR STAGING AREA
2.	CONSTRUCT STABILIZED CONSTRUCTION ENTRANCE AND INSTALL ESC MEASURES
3.	MASS GRADING
4.	UTILITY INSTALLATIONS (CONDUITS, LIGHT POLE FOUNDATIONS, ETC.)
5.	SUBBASE PAVEMENT
6.	CONSTRUCT STORMWATER FACILITIES
7.	PAVE PARKING LOT
8.	PAVEMENT STRIPING
9.	ESTABLISH TURF

• INSTALL NEW PARKING LOT AND SIGNAGE

INSTALL PAVEMENT MARKINGS

FACILITIES DISABLED THIS PHASE: • N/A

PHASE REQUIREMENTS:


PHASE	WORK AREA	CALENDAR TIME		WORK HOUR RESTRICTIONS/ REQUIREMENTS		CLOSURE HOURS	LIQUIDATED DAMAGES		PERATIONAL ICTIONS
1	A	60	NOTICE TO PROCEED	NONE	NONE	Х	\$1,500/DAY OR PORTION THEREOF	NONE	
 1	l		2		3		4		

GENERAL PHASING NOTES:

1. TEMPORARY CONSTRUCTION FENCE TO BE CONSTRUCTED PRIOR TO PARKING LOT CONSTRUCTION. THE SECURITY FENCE SHALL BE MAINTAINED IN GOOD WORKING ORDER AT ALL TIMES.


2. CONSTRUCTION VEHICLES SHALL USE THE DESIGNATED HAUL ROUTE AT ALL TIMES DURING THE COURSE OF CONSTRUCTION.

7	8	_
AUTO PARKIN(AUTO	McFarland Johnson Engineers, Planning & Construction Administration 15 FISHERS ROAD; SUITE 200 PITTSFORD, NEW YORK 14534 P:585-905-0970 F:585-905-0882 Pittsford@mjinc.com PROJECT MILESTONE FINAL PLANS NO. DATE DESCRIPTION	A
PARKIN PARKIN	CLIENT: SYRACUSE HANCOCK INTERNATIONAL AIRPORT 1000 COLONEL EILEEN COLLINS BOULEVARD SYRACUSE, NEW YORK 13212 PROJECT: PROJECT: PROJECT: LOT #3 DESIGN	B
	DRAWN LDW DESIGNED LDW CHECKED AJF SCALE 1"=40' DATE AUGUST 2022 PROJECT 18831.02	D
	BID SET IT IS A VIOLATION OF LAW FOR ANY PERSON, UNLESS THEY ARE ACTING UNDER THE DIRECT DIRECTION OF A LICENSED PROFESSIONAL ENGINEER, ARCHITECT, LANDSCAPE ARCHITECT, OR LAND SURVEYOR, TO ALTER AN ITEM IN ANY WAY. IF AN ITEM BEARING THE STAMP OF A LICENSED PROFESSIONAL IS ALTERED, THE ALTERING ENGINEER, ARCHITECT, LANDSCAPE ARCHITECT, OR LAND SURVEYOR SHALL STAMP THE DOCUMENT AND INCLUDE THE NOTATION "ALTERED BY" FOLLOWED BY THEIR SIGNATURE, THE DATE OF SUCH ALTERATION, AND A SPECIFIC DESCRIPTION OF THE ALTERATION. DRAWING TITLE CONSTRUCTION SAFETY & PHASING PLAN	E
0 150 300 450 FT SCALE	DRAWING NUMBER CS-1 4 OF 13	
7	8	J

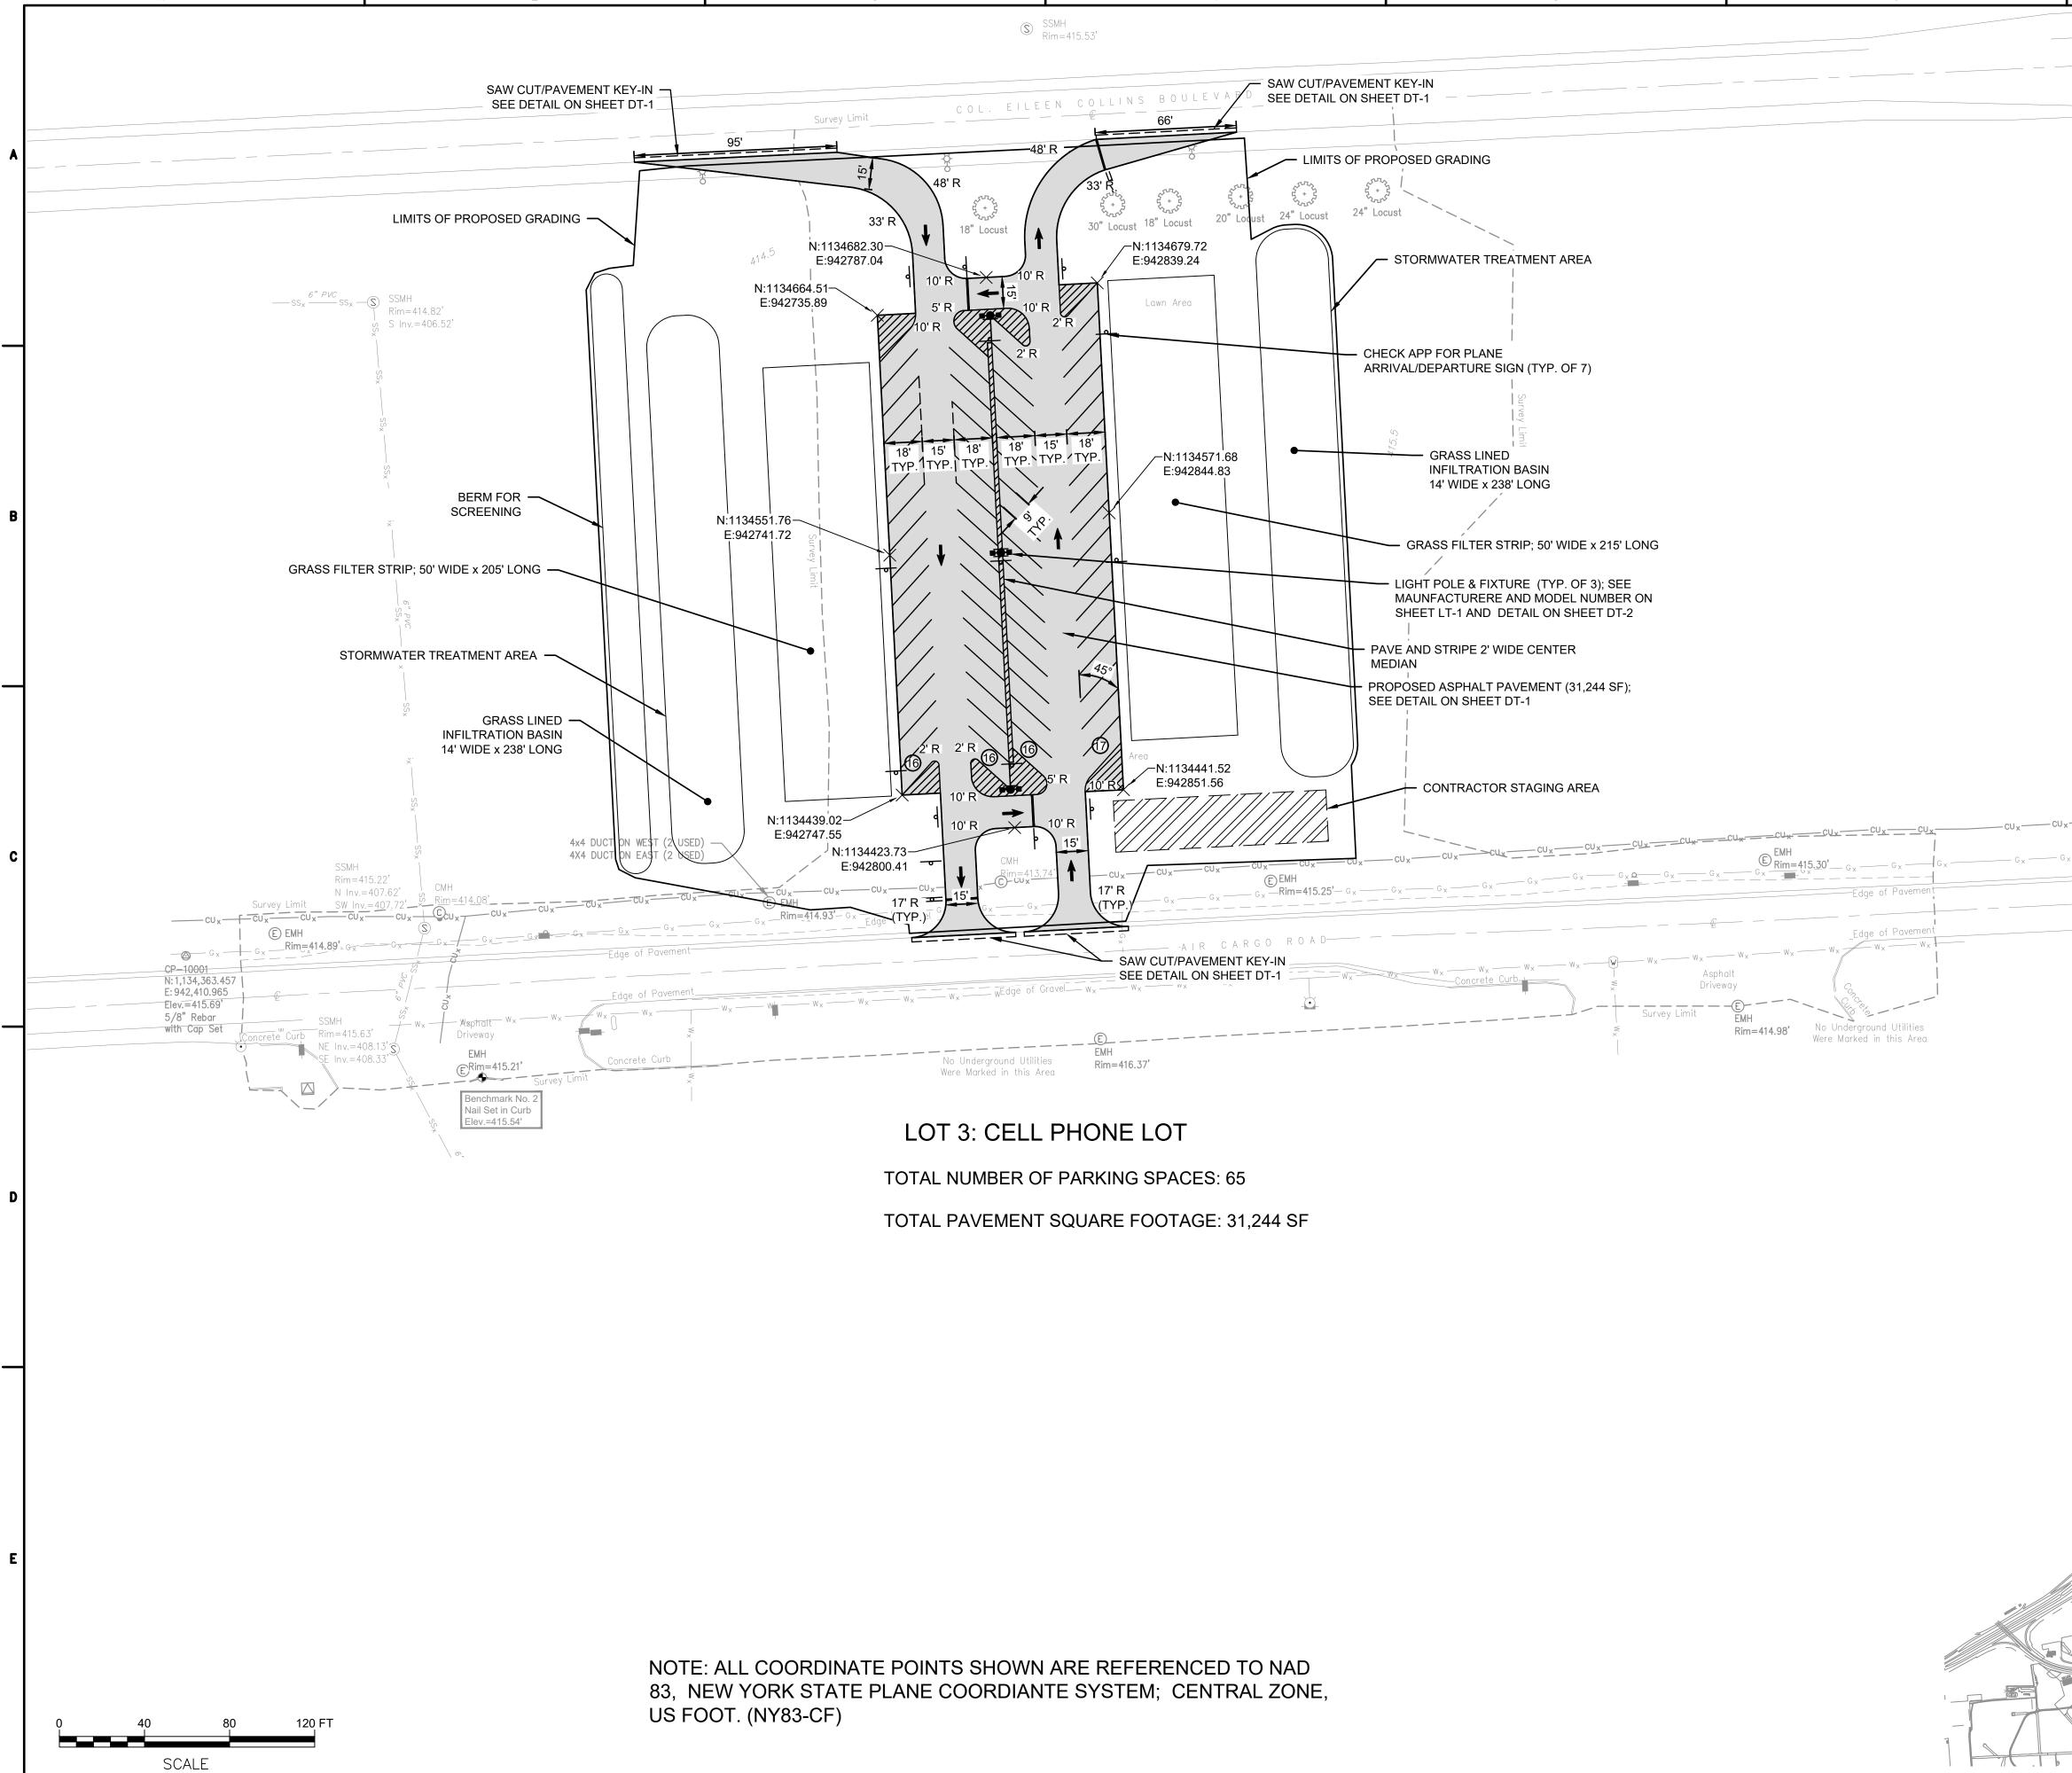





7		8		_
LEGEND: NEW PAVEMENT AREA		Engineers, Plannin 15 FISHE PITTSFO P:585-90 Pitt PROJECT MILES	A Construction Administration RS ROAD; SUITE 200 RD, NEW YORK 14534 5-0970 F:585-905-0882 sford@mjinc.com STONE AL PLANS DESCRIPTION	•
PARKING STALL COUNT PAVEMENT CORE LOCATION	C-1			
BORING LOCATION INFILTRATION TEST LOCATION	B-1 O U U U U U U U U U U U U U	ERNATIONAL AIRPORT	YORK 13212 DT EXPANSIONS SIGN	В
CU _x — CU ₃ - G _x — G _x		CLIENT: SYRACUSE HANCOCK INTERNATIONAL AII 1000 COLONEL EILEEN COLLINS BOULEV	PROJECT: PROJECT: SURFACE PARKING LOT EXPANSIONS LOT #3 DESIGN	с
		DRAWN DESIGNED CHECKED SCALE DATE PROJECT	LDW LDW AJF 1"=40' AUGUST 2022 18831.02	D
		В	ID SET	
		ARE ACTING UNDER T PROFESSIONAL EN- ARCHITECT, OR LAND WAY. IF AN ITEM B PROFESSIONAL IS / ARCHITECT, LANDSCAF SHALL STAMP THE DO "ALTERED BY" FOLLOW	LAW FOR ANY PERSON, UNLESS THEY THE DIRECT DIRECTION OF A LICENSED GINEER, ARCHITECT, LANDSCAPE SURVEYOR, TO ALTER AN ITEM IN ANY EARING THE STAMP OF A LICENSED ALTERED, THE ALTERING ENGINEER, PE ARCHITECT, OR LAND SURVEYOR OCUMENT AND INCLUDE THE NOTATION WED BY THEIR SIGNATURE, THE DATE N, AND A SPECIFIC DESCRIPTION OF	E
PARKING LOT 3 SITE			AYOUT PLAN	
		DRAWING NUMI	BER SP-1 OF 13	
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	A A A Construction Administration Construction Cons	
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PARKING LOT 3 SITE	BID SET	
LOCATION SKETCH 7	6 OF 13	

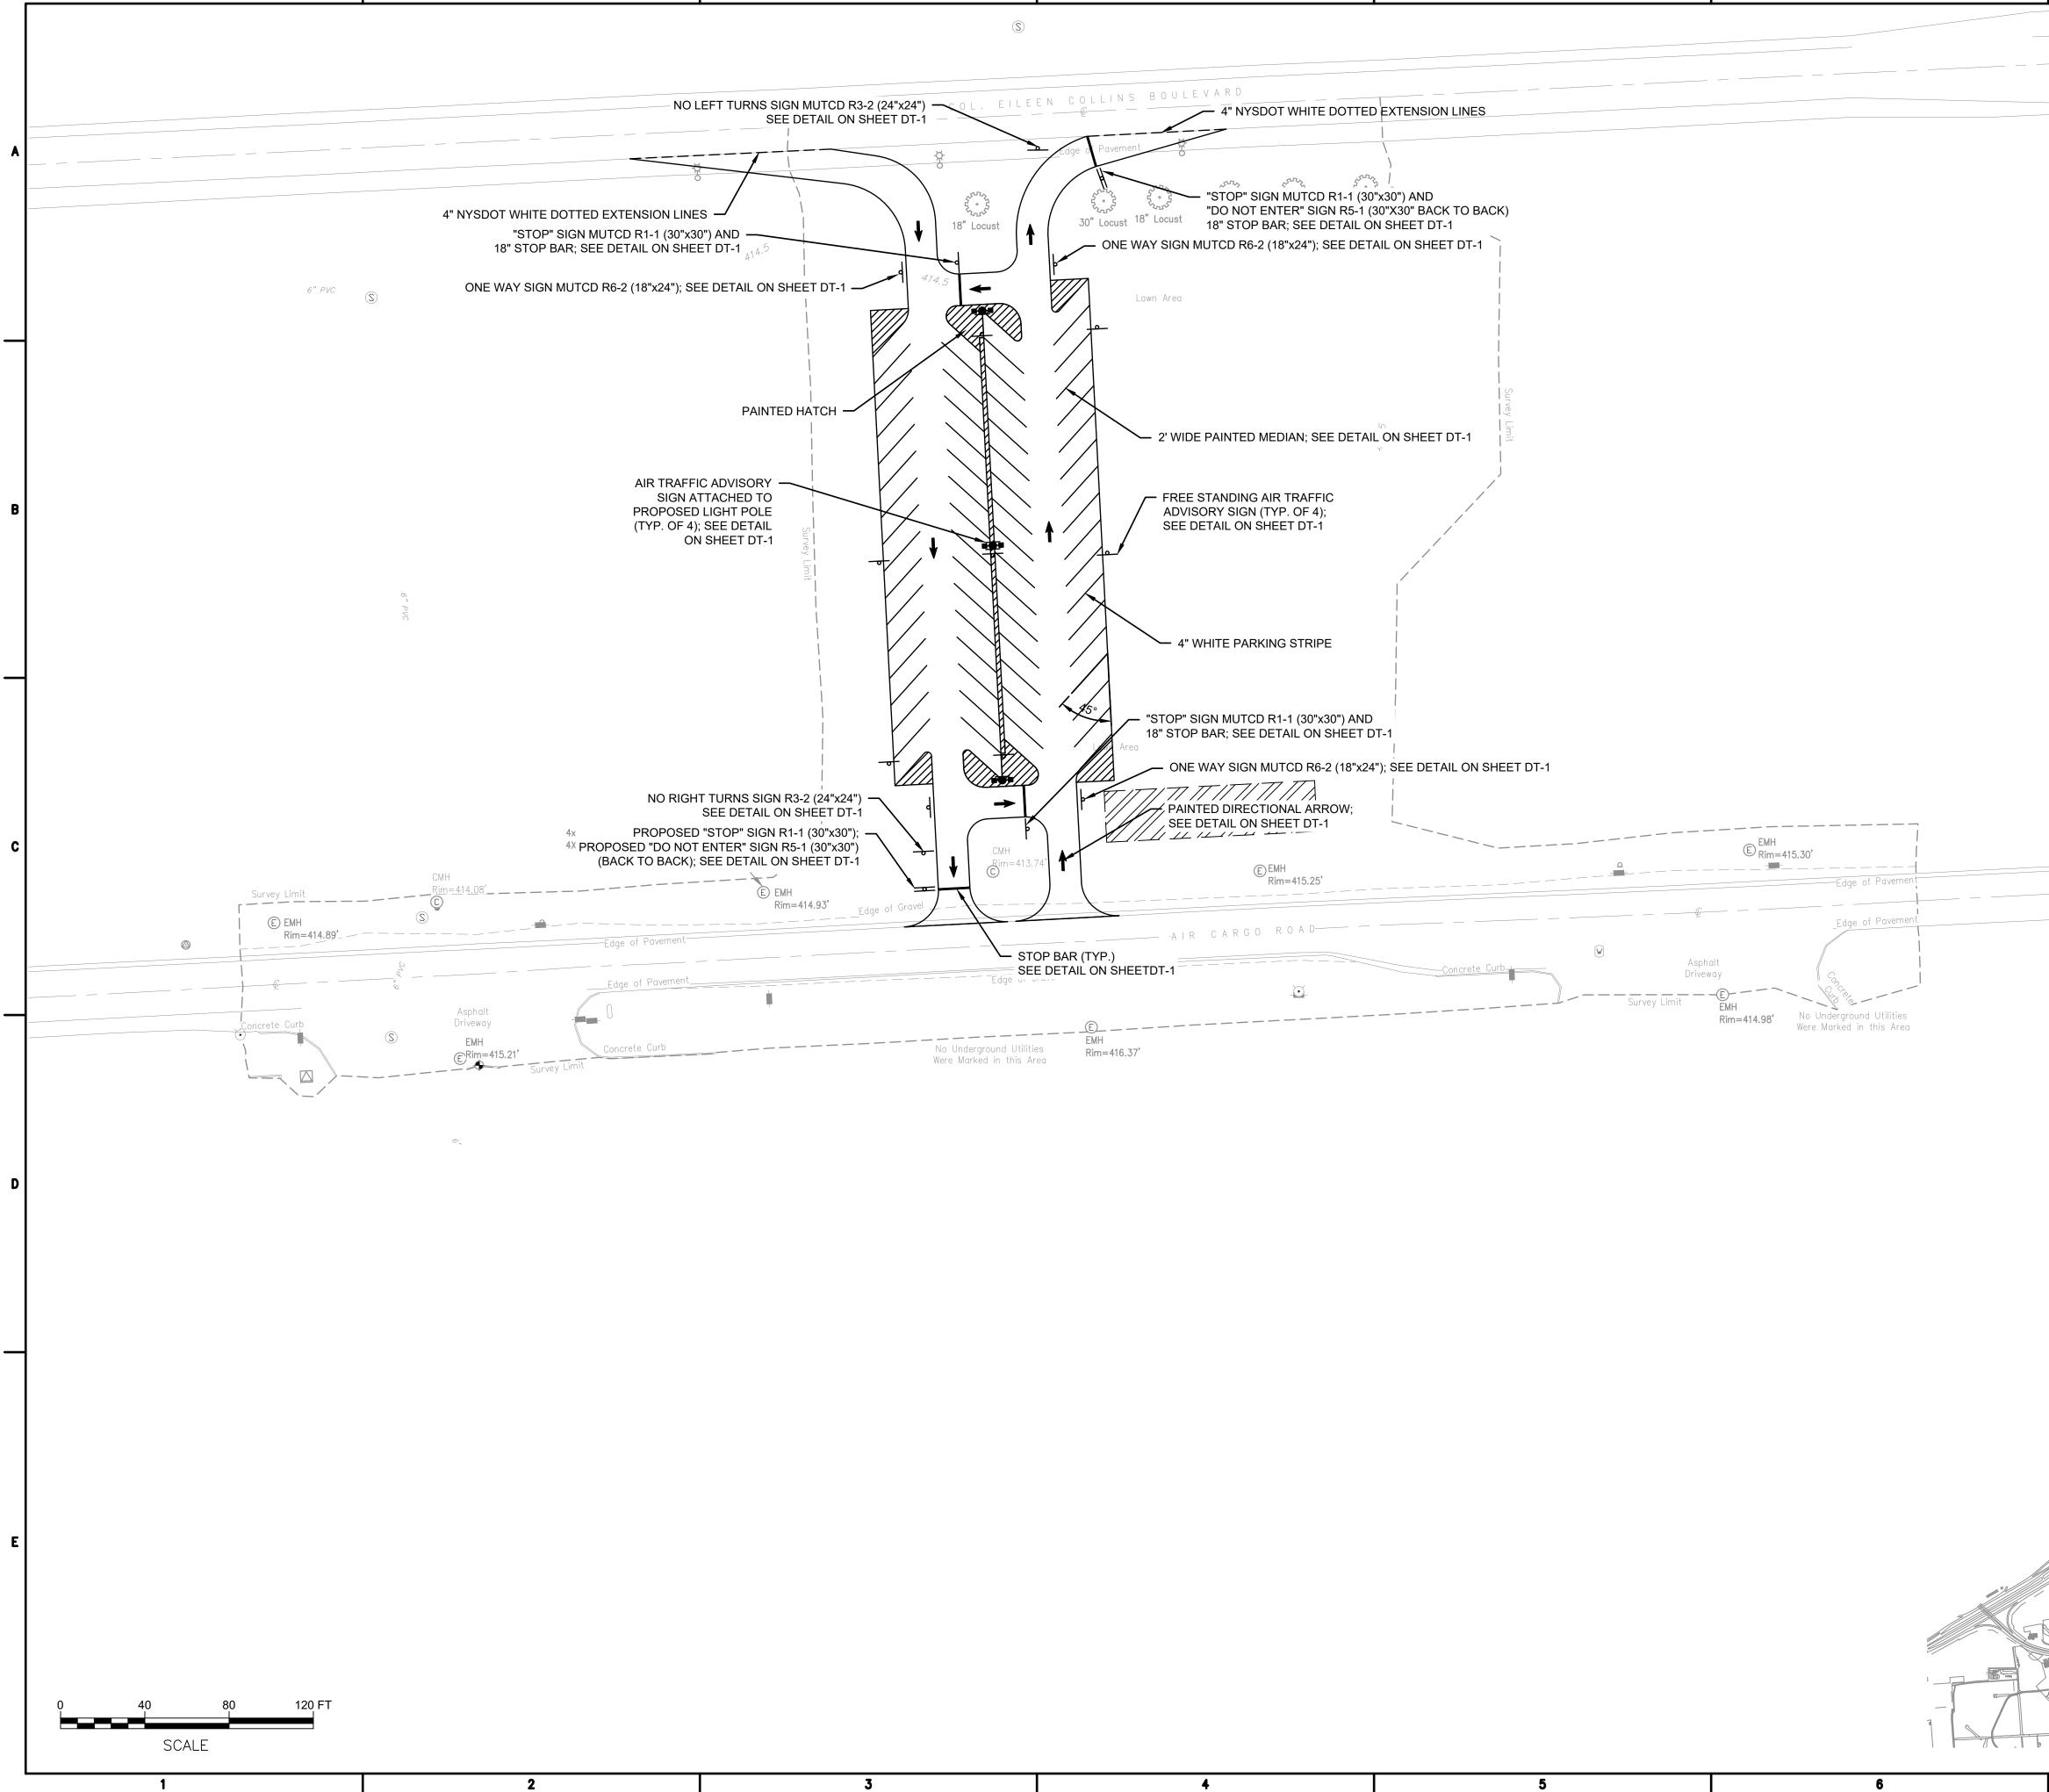




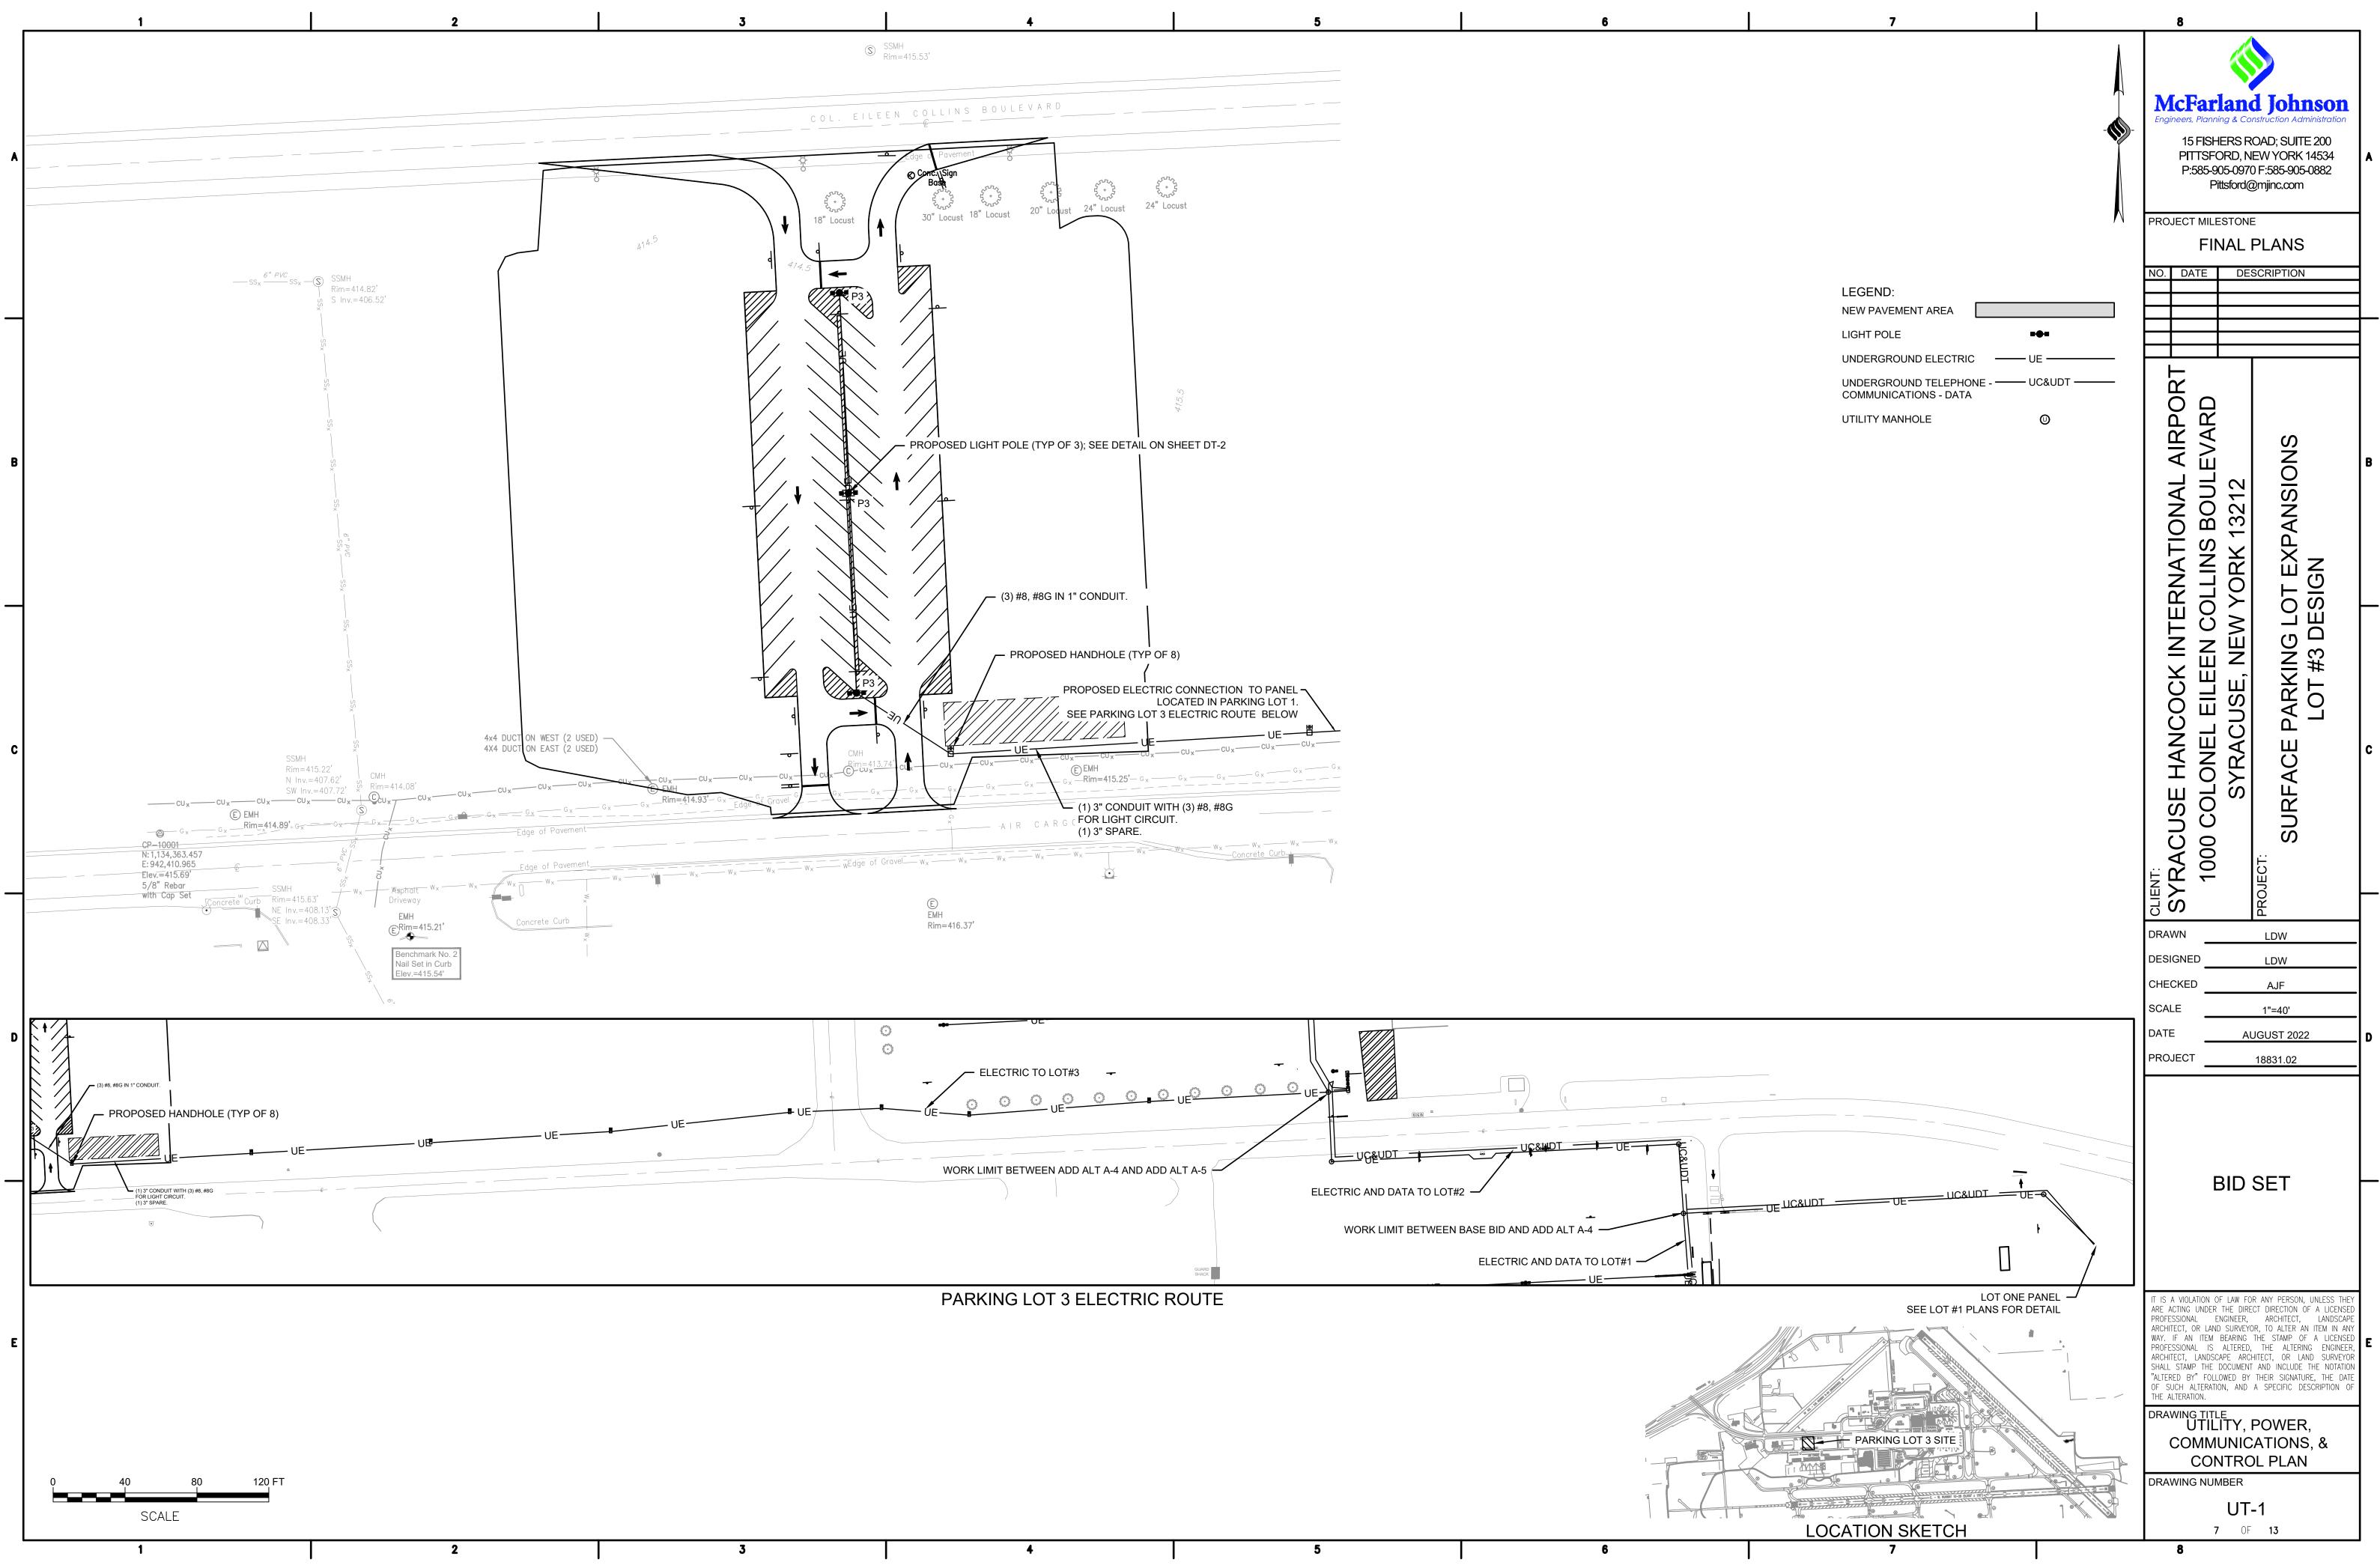

rr. Watts	Lum. Watts	Lum. Lumens	Mounting Height	Pole Manufacturer	Pole Model Number
42	121	18513	28 FEET	McGraw Edison	SSA6M25WFN2
	7				
Max/Min					
8.14					

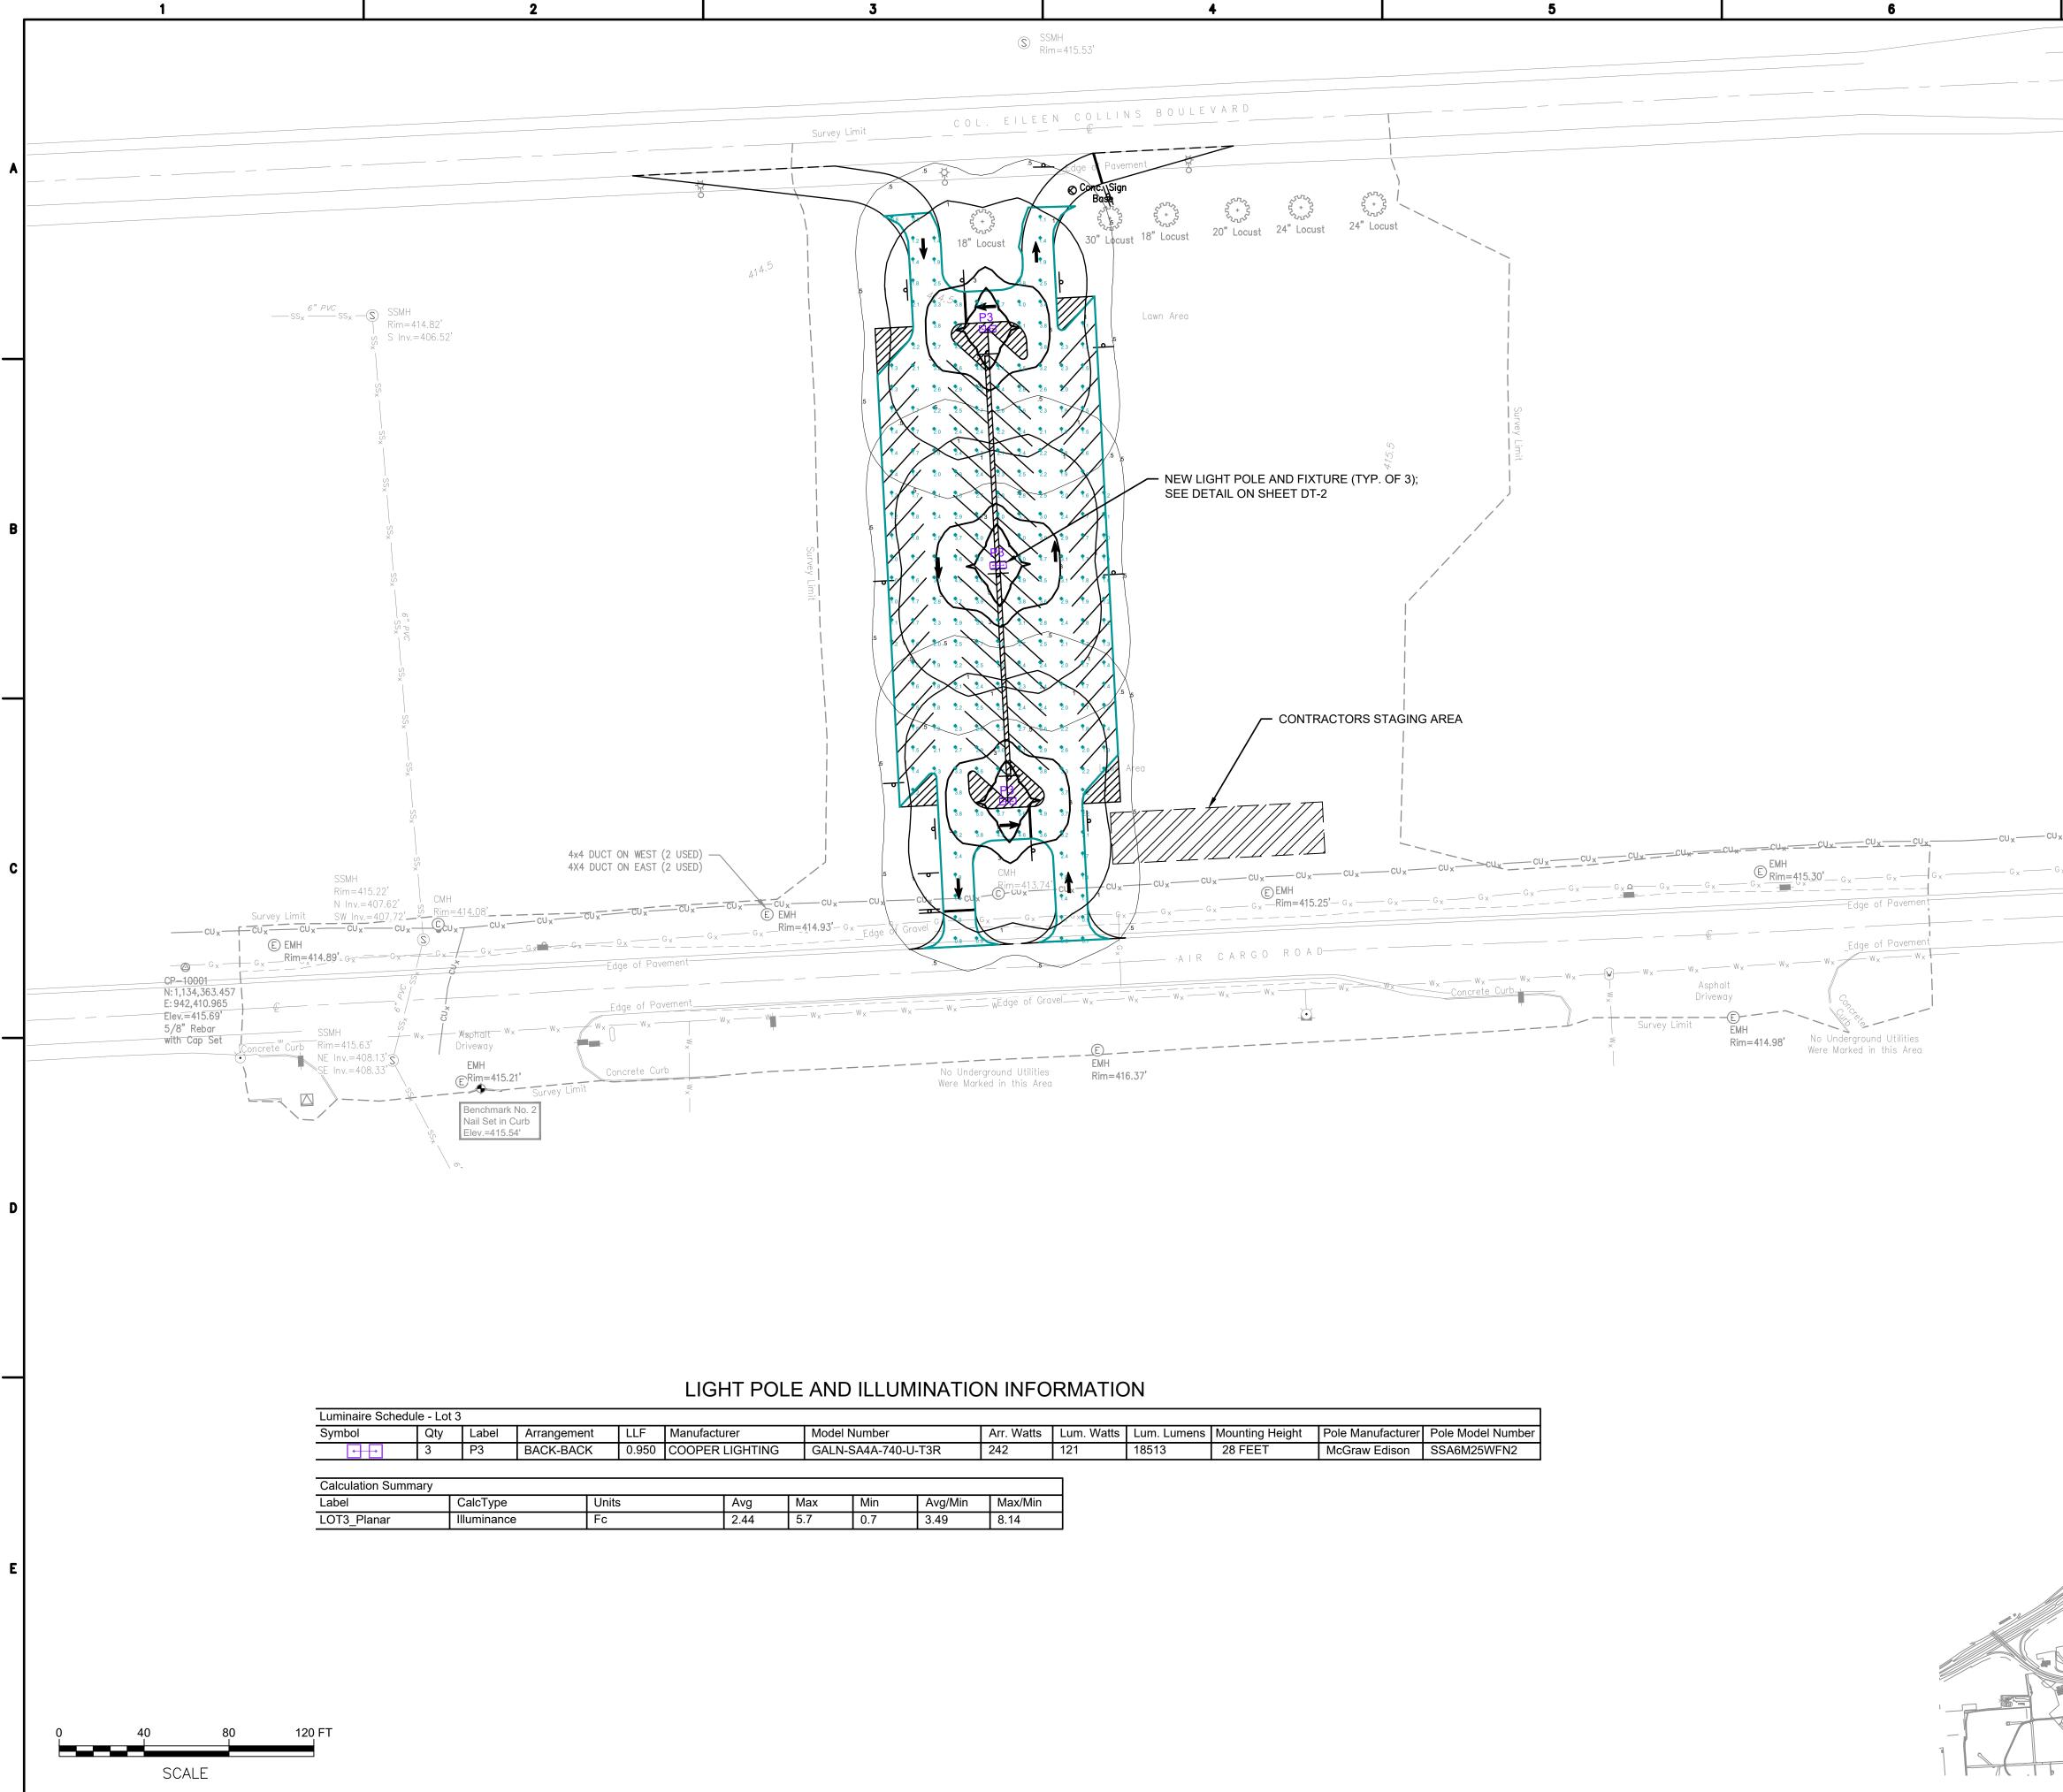	7	1	8				-
			Engineers, F 15 F PITT P:55	FISHI TSFC 85-90 Pit MILE	ng & Co ERS R DRD, N D5-0970 tsford(tsford(STONI	Description CAD; SUITE 200 IEVV YORK 14534 0 F:585-905-0882 20 mjinc.com E PLANS SCRIPTION	A
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	McFarland Johnson Engineers, Planning & Construction Administration 15 FISHERS ROAD; SUITE 200 PITTSFORD, NEW YORK 14534 P:585-905-0970 F:585-905-0882 Pittsford@mjinc.com PROJECT MILESTONE FINAL PLANS NO. DATE DESCRIPTION Image: Planning & Construction Administration	•
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	FR	OSION AND SEDIMENT CONTROL PLAN NOTES:
A		THE EROSION AND SEDIMENT CONTROL PLAN IS INTENDED TO REPRESENT A CONCEPTUAL APPROACH TO EROSION AND SEDIMENT CONTROL. IT IS FURTHER INTENDED THAT THE OWNER AND CONTRACTOR SHALL IMPLEMENT PRACTICES, AS REQUIRED, TO CONTROL EROSION AND SEDIMENT IN ACCORDANCE WITH THE NEW YORK STANDARDS AND SPECIFICATIONS FOR EROSION AND SEDIMENT CONTROL AND SWPPP.
	2.	INSTALL SILT FENCE, AND ALL OTHER EROSION CONTROL MEASURES AS INDICATED ON THE PLAN PRIOR TO THE START OF ANY EXCAVATION WORK. EROSION CONTROL MEASURES WILL BE IMPLEMENTED IN ACCORDANCE WITH THE NEW YORK STANDARDS AND SPECIFICATIONS FOR EROSION AND SEDIMENT CONTROL, NEW YORK STATE DEPARTMENT OF ENVIRONMENTAL CONSERVATION AND THE GOVERNING MUNICIPALITY REQUIREMENTS.
	3.	REMOVE AND STOCKPILE TOPSOIL IN ACCORDANCE WITH THE EROSION AND SEDIMENT CONTROL PLAN. REPLACE TOPSOIL TO A MINIMUM 4" DEPTH. ALL DISTURBED AREAS ARE TO BE HYDROSEEDED IN ACCORDANCE WITH THE EROSION AND SEDIMENT CONTROL PLANS.
	4.	CONTRACTOR SHALL BE RESPONSIBLE FOR THE MAINTENANCE AND REMOVAL OF TEMPORARY SEDIMENTATION CONTROLS, INCLUDING INLET PROTECTION AND SILT FENCE. EROSION CONTROL MEASURES SHALL NOT BE REMOVED BEFORE AREAS HAVE BEEN PROPERLY STABILIZED.
	5.	CONTRACTOR SHALL MAINTAIN A STOCK PILE OF EROSION AND SEDIMENT CONTROL MEASURES ON SITE AS INDICATED ON THE PLAN.
3	6.	NO PETROLEUM PRODUCTS ARE TO BE STORED ON SITE WITHOUT PRIOR APPROVAL OF THE LOCAL STORMWATER INSPECTOR. ANY PETROLEUM ON SITE WILL COMPLY WITH ALL LOCAL, STATE, AND FEDERAL GOVERNMENT REGULATIONS.
	7.	WRAP YARD INLET GRATES IN FILTER FABRIC PROGRESSIVELY AS STORM SEWER AND YARD INLETS ARE INSTALLED.
	8.	ALL EROSION CONTROL MEASURES ARE TO BE REPLACED WHENEVER THEY BECOME CLOGGED OR INOPERABLE AND SHALL BE REPLACED AT A MINIMUM OF EVERY 3 MONTHS.
	9.	JUTE MESH WILL BE USED ON SLOPES STEEPER THAN 3:1 AND WHEREVER NECESSARY TO CONTROL EROSION AND SILTATION OF EXISTING DRAINAGE SYSTEMS AS ORDERED BY THE ENGINEER.
	10.	ALL DISTURBED AREAS SHALL BE FINISH GRADED TO PROMOTE VEGETATION ON ALL EXPOSED AREAS AS SOON AS PRACTICABLE. STABILIZATION PRACTICES (TEMPORARY/PERMANENT SEEDING, MULCHING, GEOTEXTILES, ETC.) MUST BE IMPLEMENTED WITHIN SEVEN (7) DAYS WHERE CONSTRUCTION ACTIVITIES HAVE TEMPORARILY OR PERMANENTLY CEASED, AND NOT EXPECTED TO RESUME WITHIN FOURTEEN (14) DAYS.
c	11.	ALL RIP-RAP OUTLET PROTECTION TO BE CONSTRUCTED PER NYSDEC STANDARDS AND SPECIFICATIONS FOR EROSION AND SEDIMENT CONTROL.
	12.	CONTRACTOR SHALL TAKE THE NECESSARY MEASURES, INCLUDING WATER SPRINKLING, TO PROVIDE DUST CONTROL DURING CONSTRUCTION.
	A.	THE CONTRACTOR SHALL BE RESPONSIBLE FOR THE MAINTENANCE OF ALL TEMPORARY AND PERMANENT EROSION CONTROL FEATURES THROUGHOUT THE DURATION OF CONSTRUCTION. ALL SEDIMENT TRAPPING DEVICES AND INLET PROTECTION DEVICES SHALL BE CLEANED OF ACCUMULATED SILT WHEN STORAGE CAPACITY HAS BEEN REDUCED BY 50% OF THEIR DESIGN CAPACITY. ALL SEDIMENT SHALL BE REMOVED FROM BEHIND SILT FENCE AND STRAW BALES WHEN IT ACCUMULATES TO A MAXIMUM HEIGHT OF 6".
		AFTER VEGETATION HAS BEEN SUBSTANTIALLY ESTABLISHED, EXCAVATE SWALES OF ACCUMULATED SILT. RE-ESTABLISHED VEGETATION ON DISTURBED AREAS. SEDIMENT COLLECTED BY EROSION CONTROL MEASURES SHALL BE DISPOSED OF BY SPREADING ON-SITE OR HAULED AWAY IF DETERMINED TO BE UNSUITABLE FOR FILL.
	12.	ALL DISTURBED AREAS SHALL BE STABILIZED, SEEDED AND MULCHED WITHIN 7 DAYS OF CEASED CONSTRUCTION ACTIVITY.
	13.	TOTAL PROJECT DISTURBANCE AREA PER THE NYSDEC SPDES STANDARDS IS 13.8 ACRES.
ס	14.	ALL AREAS TO REMAIN AS PERVIOUS VEGETATED AREAS SHALL BE RESTORED IN ACCORDANCE WITH THE NYS STORMWATER MANAGEMENT DESIGN MANUAL TABLE 5.3 SOIL RESTORATION REQUIREMENTS.
		PERMANENT SEEDING NON-SLOPED AREAS: 1. IF SOILS ARE COMPACTED, SCARIFY UPPER TWO INCHES BY BACKBLADING WITH
		DOZER, RAKING, OR DISKING.
		 PLACE TOPSOIL TO A MINIMUM DEPTH OF 4 INCHES. SEED PER NYSDOT ESTABLISHING TURF SPECIFICATIONS; NYSDOT ITEM 610.1602.
		 FERTILIZE WITH 600 POUNDS PER ACRE OF 10-10-10. LIME TO ACHIEVE A PH OF NOT LESS THAN 5.5 OR GREATER THAN 7.6. IF HYDROSEEDER IS NOT USED, SEED AND FERTILIZER SHOULD BE LIGHTLY RAKED INTO SOIL.
		5. MULCH WITH CLEAN (WEED FREE) STRAW IF SPECIFIED ON PLANS.
		PERMANENT SEEDING SLOPED AREAS:
		1. IF SOILS ARE COMPACTED, SCARIFY UPPER TWO INCHES BY BACKBLADING WITH DOZER, RAKING, OR DISKING.
		2. PLACE TOPSOIL TO A MINIMUM DEPTH OF 4 INCHES.
		 FERTILIZE WITH 600 POUNDS PER ACRE OF 10-10-10. LIME TO ACHIEVE A PH OF NOT LESS THAN 5.5 OR GREATER THAN 7.6. IF HYDROSEEDER IS NOT USED, SEED AND FERTILIZER SHOULD BE LIGHTLY RAKED INTO SOIL.
		 IMMEDIATELY SEED NYSDOT ESTABLISHING TURF SPECIFICATIONS; NYSDOT ITEM 610.1602.
		5. PROVIDE JUTE MESH IF SPECIFIED ON PLANS OR MULCH WITH CLEAN (WEED FREE) STRAW.

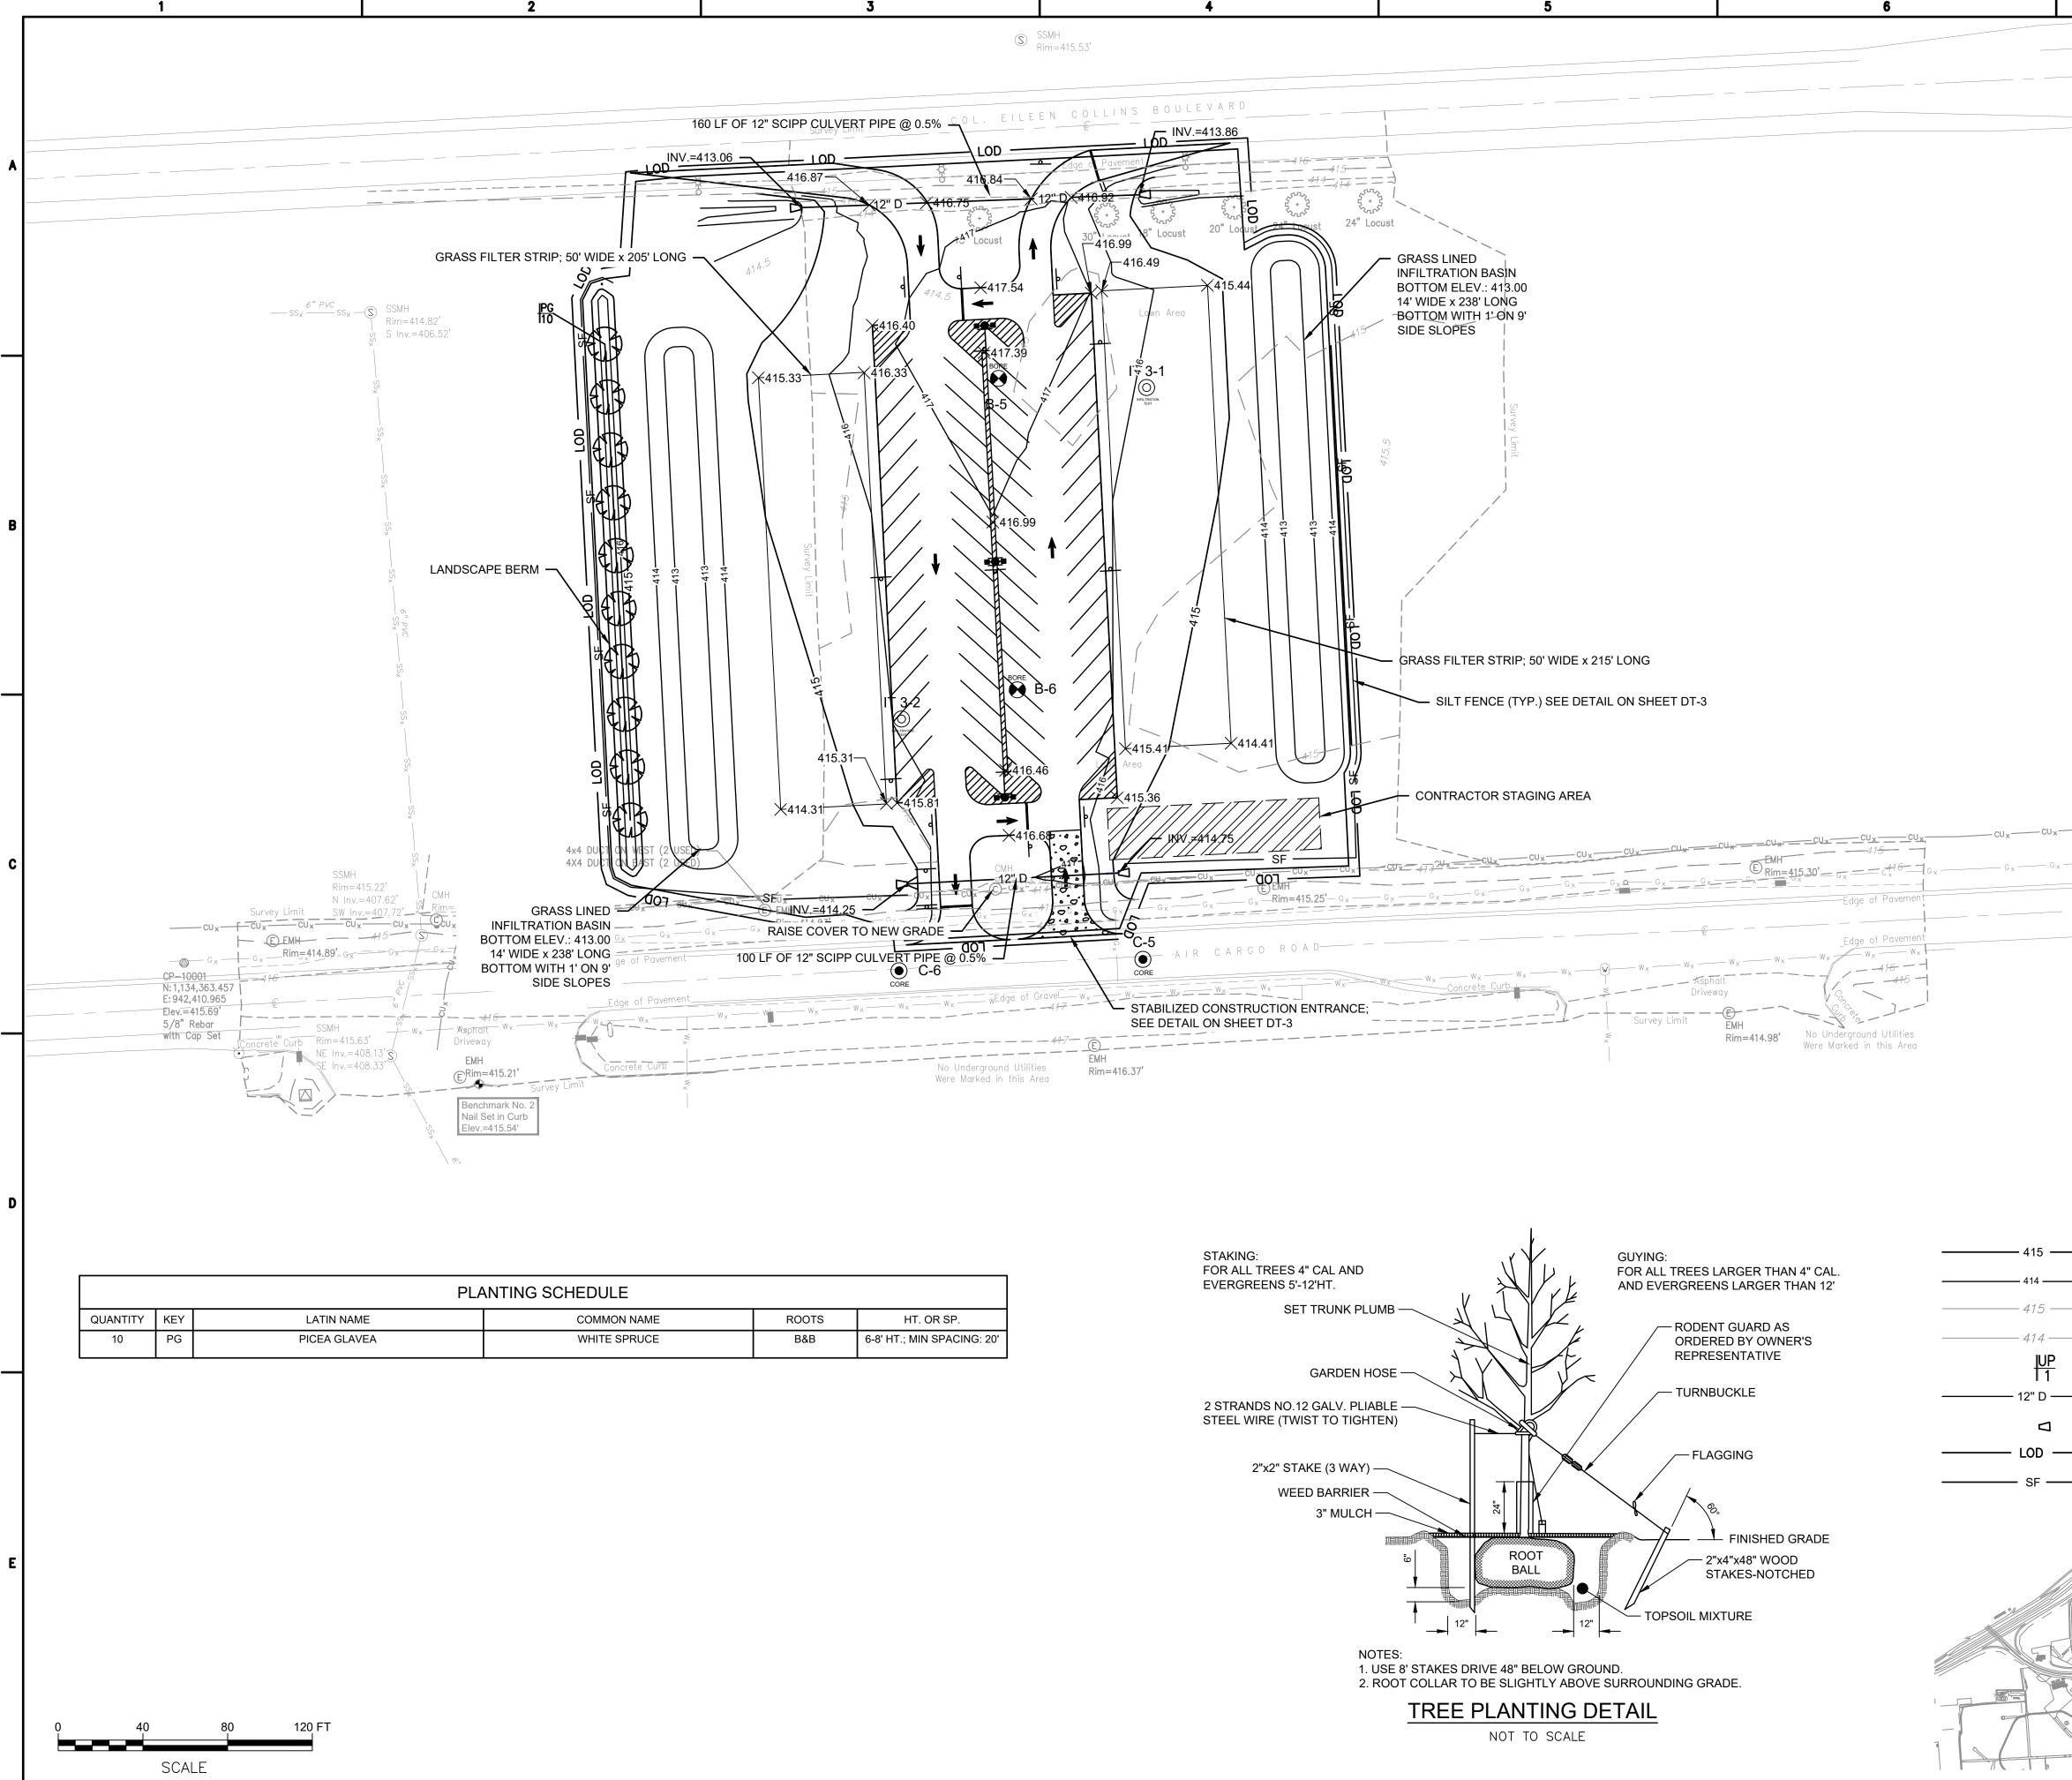- 2

EACH WORK DAY UNLESS:

THAN 5 ACRES.

TEMPORARY SEEDING:

- CONSTANT; 2 TONS PER ACRE.

SOIL RESTORATION NOTES:

COMPOST SPECIFICATIONS:

PLANTS.

1

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3

5

WINTER STABILIZATION:

1. PREPARE A SNOW MANAGEMENT PLAN WITH ADEQUATE STORAGE FOR SNOW AND CONTROL OF MELT WATER, REQUIRING CLEARED SNOW TO BE STORED IN A MANNER NOT AFFECTING ONGOING CONSTRUCTION ACTIVITIES.

2. TO ENSURE ADEQUATE STABILIZATION OF DISTURBED SOIL IN ADVANCE OF A MELT EVENT, AREAS OF DISTURBED SOIL SHOULD BE STABILIZED AT THE END OF A. WORK WILL RESUME WITHIN 24 HOURS IN THE SAME AREA AND NO

PRECIPITATION IS FORECAST OR; B. THE WORK IS IN DISTURBED AREAS THAT COLLECT AND RETAIN

RUNOFF, SUCH AS OPEN UTILITY TRENCHES, FOUNDATION EXCAVATIONS, OR WATER MANAGEMENT AREAS. 3. IF THE SITE WILL NOT HAVE EARTH DISTURBING ACTIVITIES ONGOING DURING

THE "WINTER SEASON", ALL BARE EXPOSED SOIL MUST BE STABILIZED BY ESTABLISHED VEGETATION, STRAW OR OTHER ACCEPTABLE MULCH, MATTING, ROCK OR OTHER APPROVED MATERIAL SUCH AS ROLLED EROSION CONTROL PRODUCTS. SEEDING OF AREAS WITH MULCH COVER IS PREFERRED BUT SEEDING ALONE IS NOT ACCEPTABLE FOR PROPER STABILIZATION.

NOTE: A 5-ACRE WAIVER REQUEST MUST BE APPROVED BY THE SYRACUSE AIRPORT (MS4) PRIOR TO DISTURBING MORE

1. IF SOILS ARE COMPACTED, SCARIFY UPPER TWO INCHES BY BACKBLADING WITH DOZER, RAKING, OR DISKING. FERTILIZE WITH 300 POUNDS PER ACRE OF 10-10-10.

2. NOTE: NO FERTILIZER SHOULD BE USED AFTER OCTOBER 1ST IF THERE IS DANGER OF LEACHING INTO WATER RESOURCE.

3. IMMEDIATELY SEED AND MULCH PER NYSDOT ITEM 209.1003.

4. APPLY STRAW MULCH AS NECESSARY TO HOLD IN MOISTURE, PROTECT SOIL FROM EROSION, HOLD SEED IN PLACE, AND KEEP SOIL TEMPERATURES MORE

SOIL RESTORATION PROCEDURE:

DURING PERIODS OF RELATIVELY LOW TO MODERATE SUBSOIL MOISTURE, THE DISTURBED SUBSOILS ARE RETURNED TO ROUGH GRADE AND THE FOLLOWING SOIL RESTORATION STEPS APPLIED:

1. APPLY 3 INCHES OF COMPOST OVER SUBSOIL

2. TILL COMPOST INTO SUBSOIL TO A DEPTH OF AT LEAST 12 INCHES USING A CAT-MOUNTED RIPPER, TRACTOR-MOUNTED DISC, OR TILLER, MIXING, AND CIRCULATING AIR AND COMPOST INTO SUBSOILS

3. ROCK-PICK UNTIL UPLIFTED STONE/ROCK MATERIALS OF FOUR INCHES AND LARGER SIZE ARE CLEANED OFF THE SITE

4. APPLY TOPSOIL TO A DEPTH OF 6 INCHES

5. VEGETATE AS REQUIRED BY APPROVED PLAN.

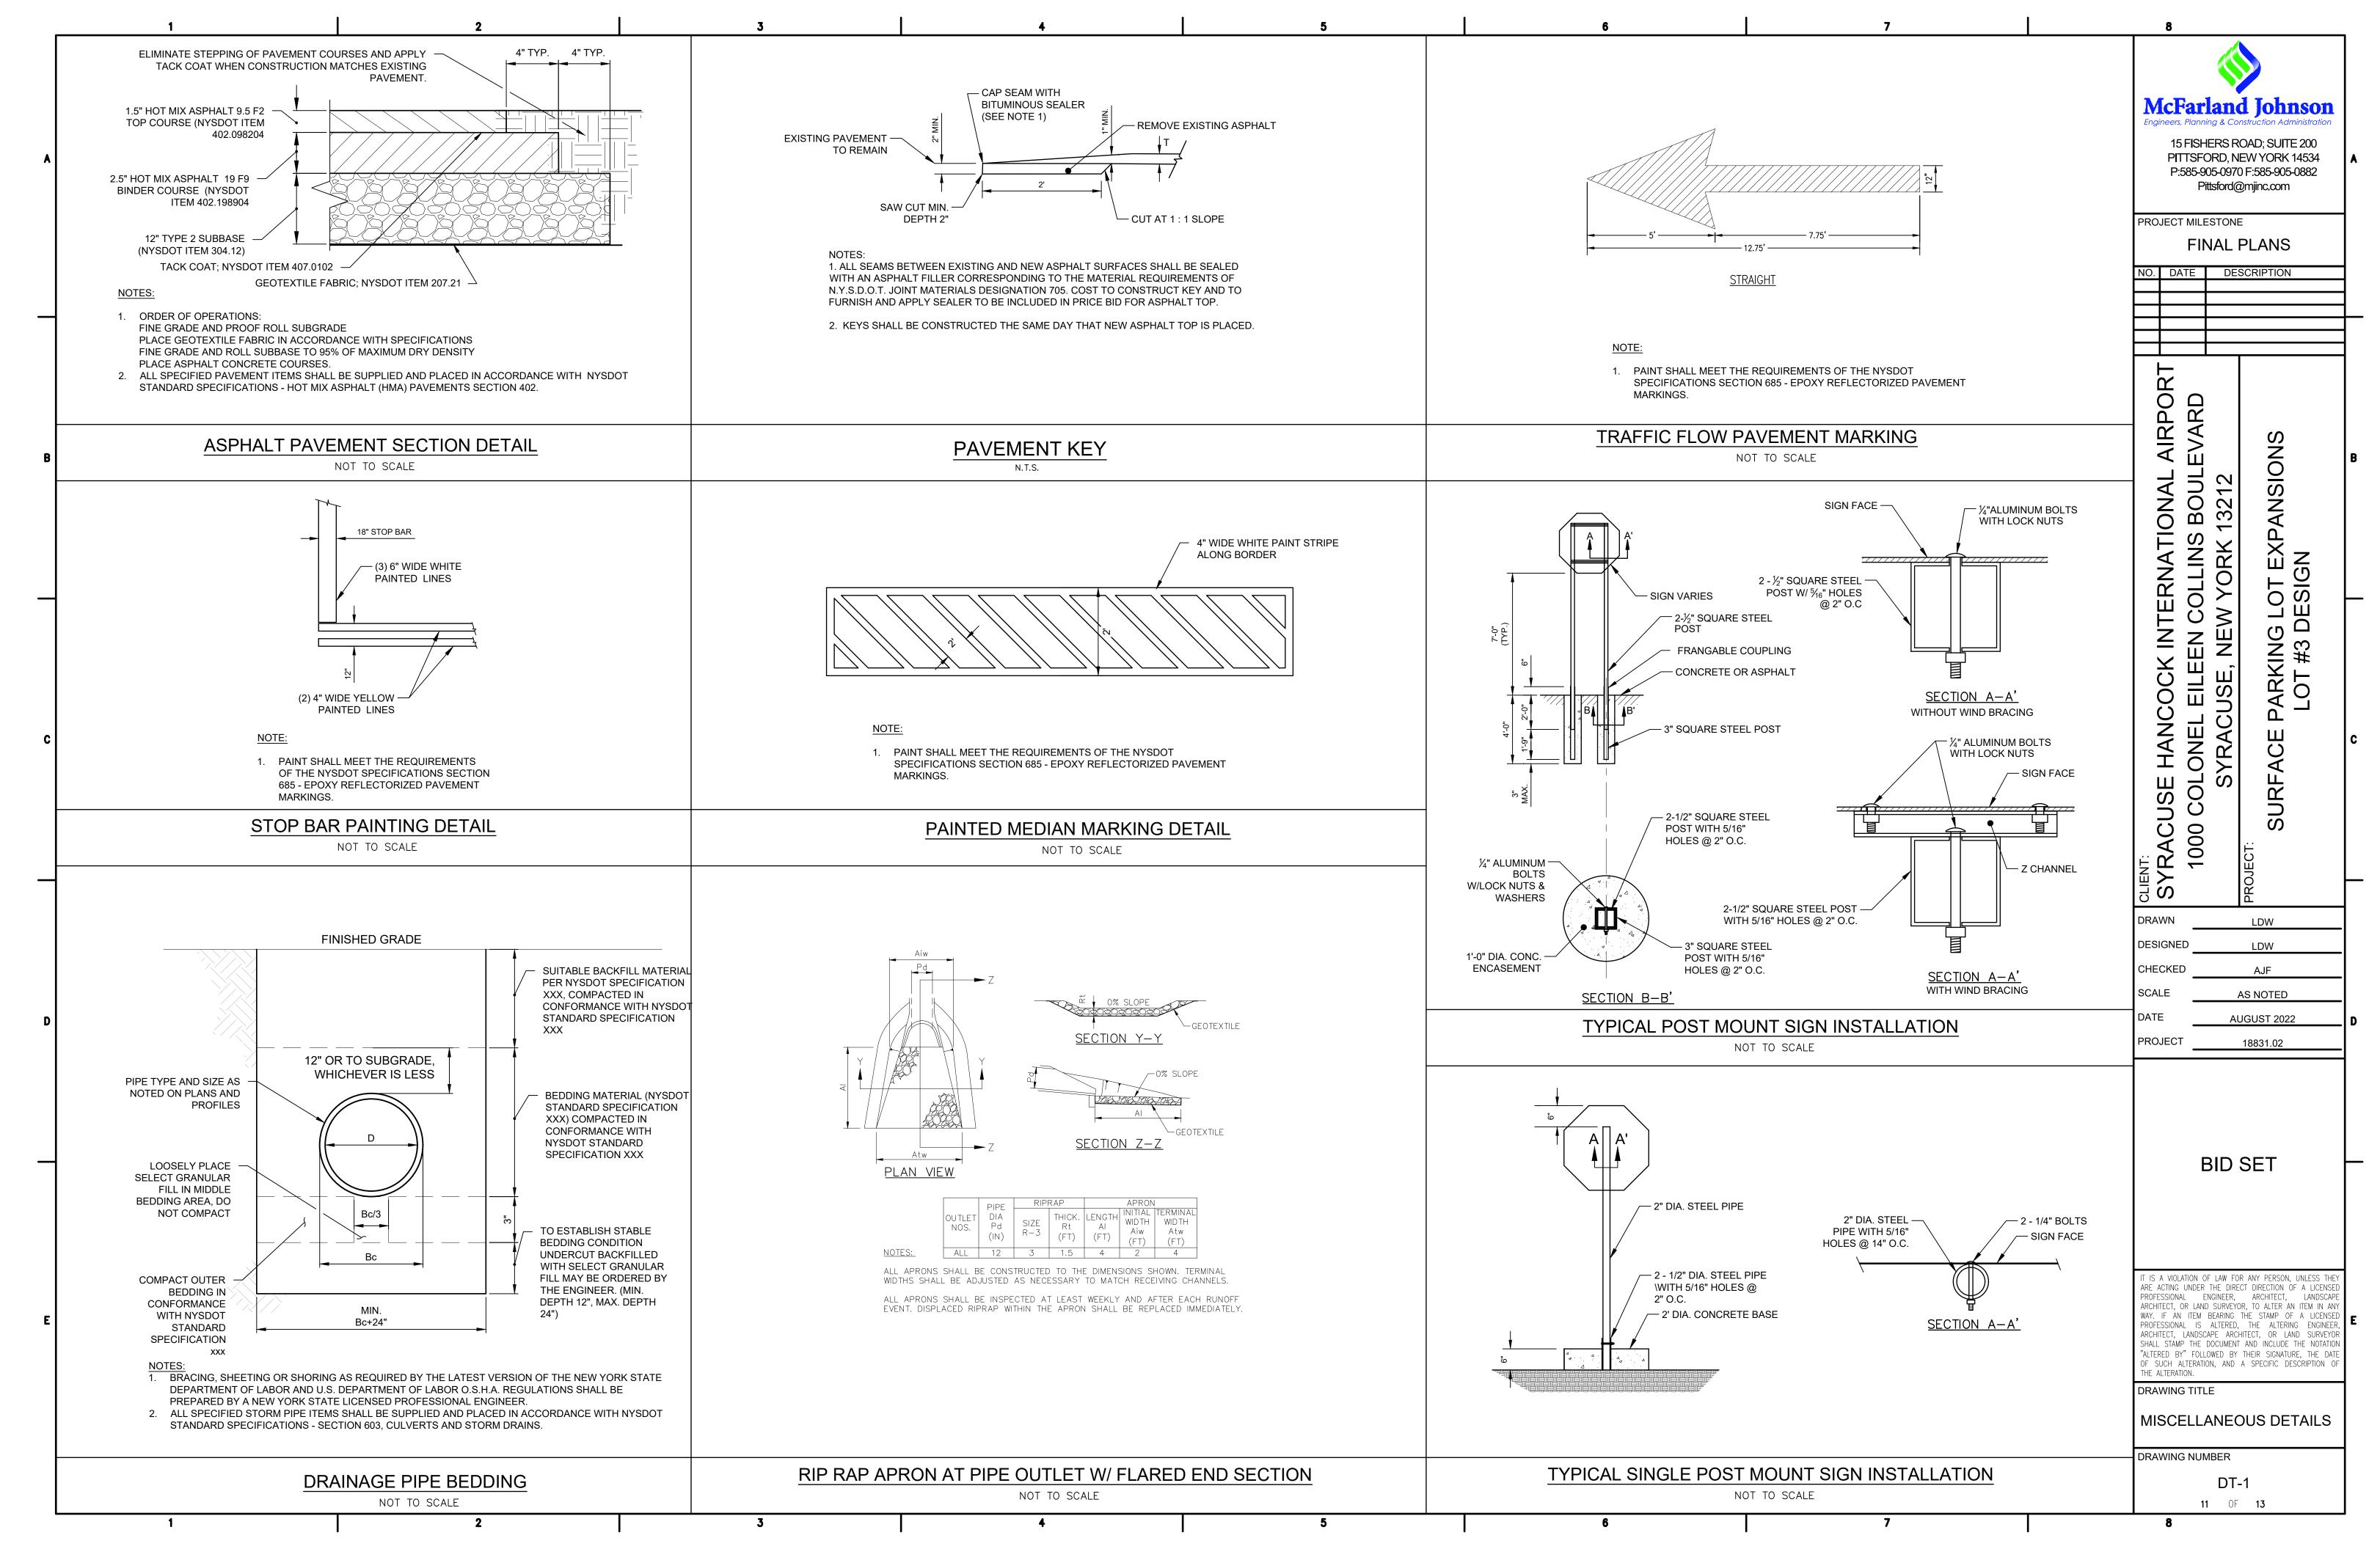
AT THE END OF THE PROJECT AN INSPECTOR SHOULD BE ABLE TO PUSH A 3/8" METAL BAR 12 INCHES INTO THE SOIL JUST WITH BODY WEIGHT. TILLING (STEP 2 ABOVE) SHOULD NOT BE PERFORMED WITHIN THE DRIP LINE OF ANY EXISTING TREES OR OVER UTILITY INSTALLATIONS THAT ARE WITHIN 24 INCHES OF THE SURFACE.

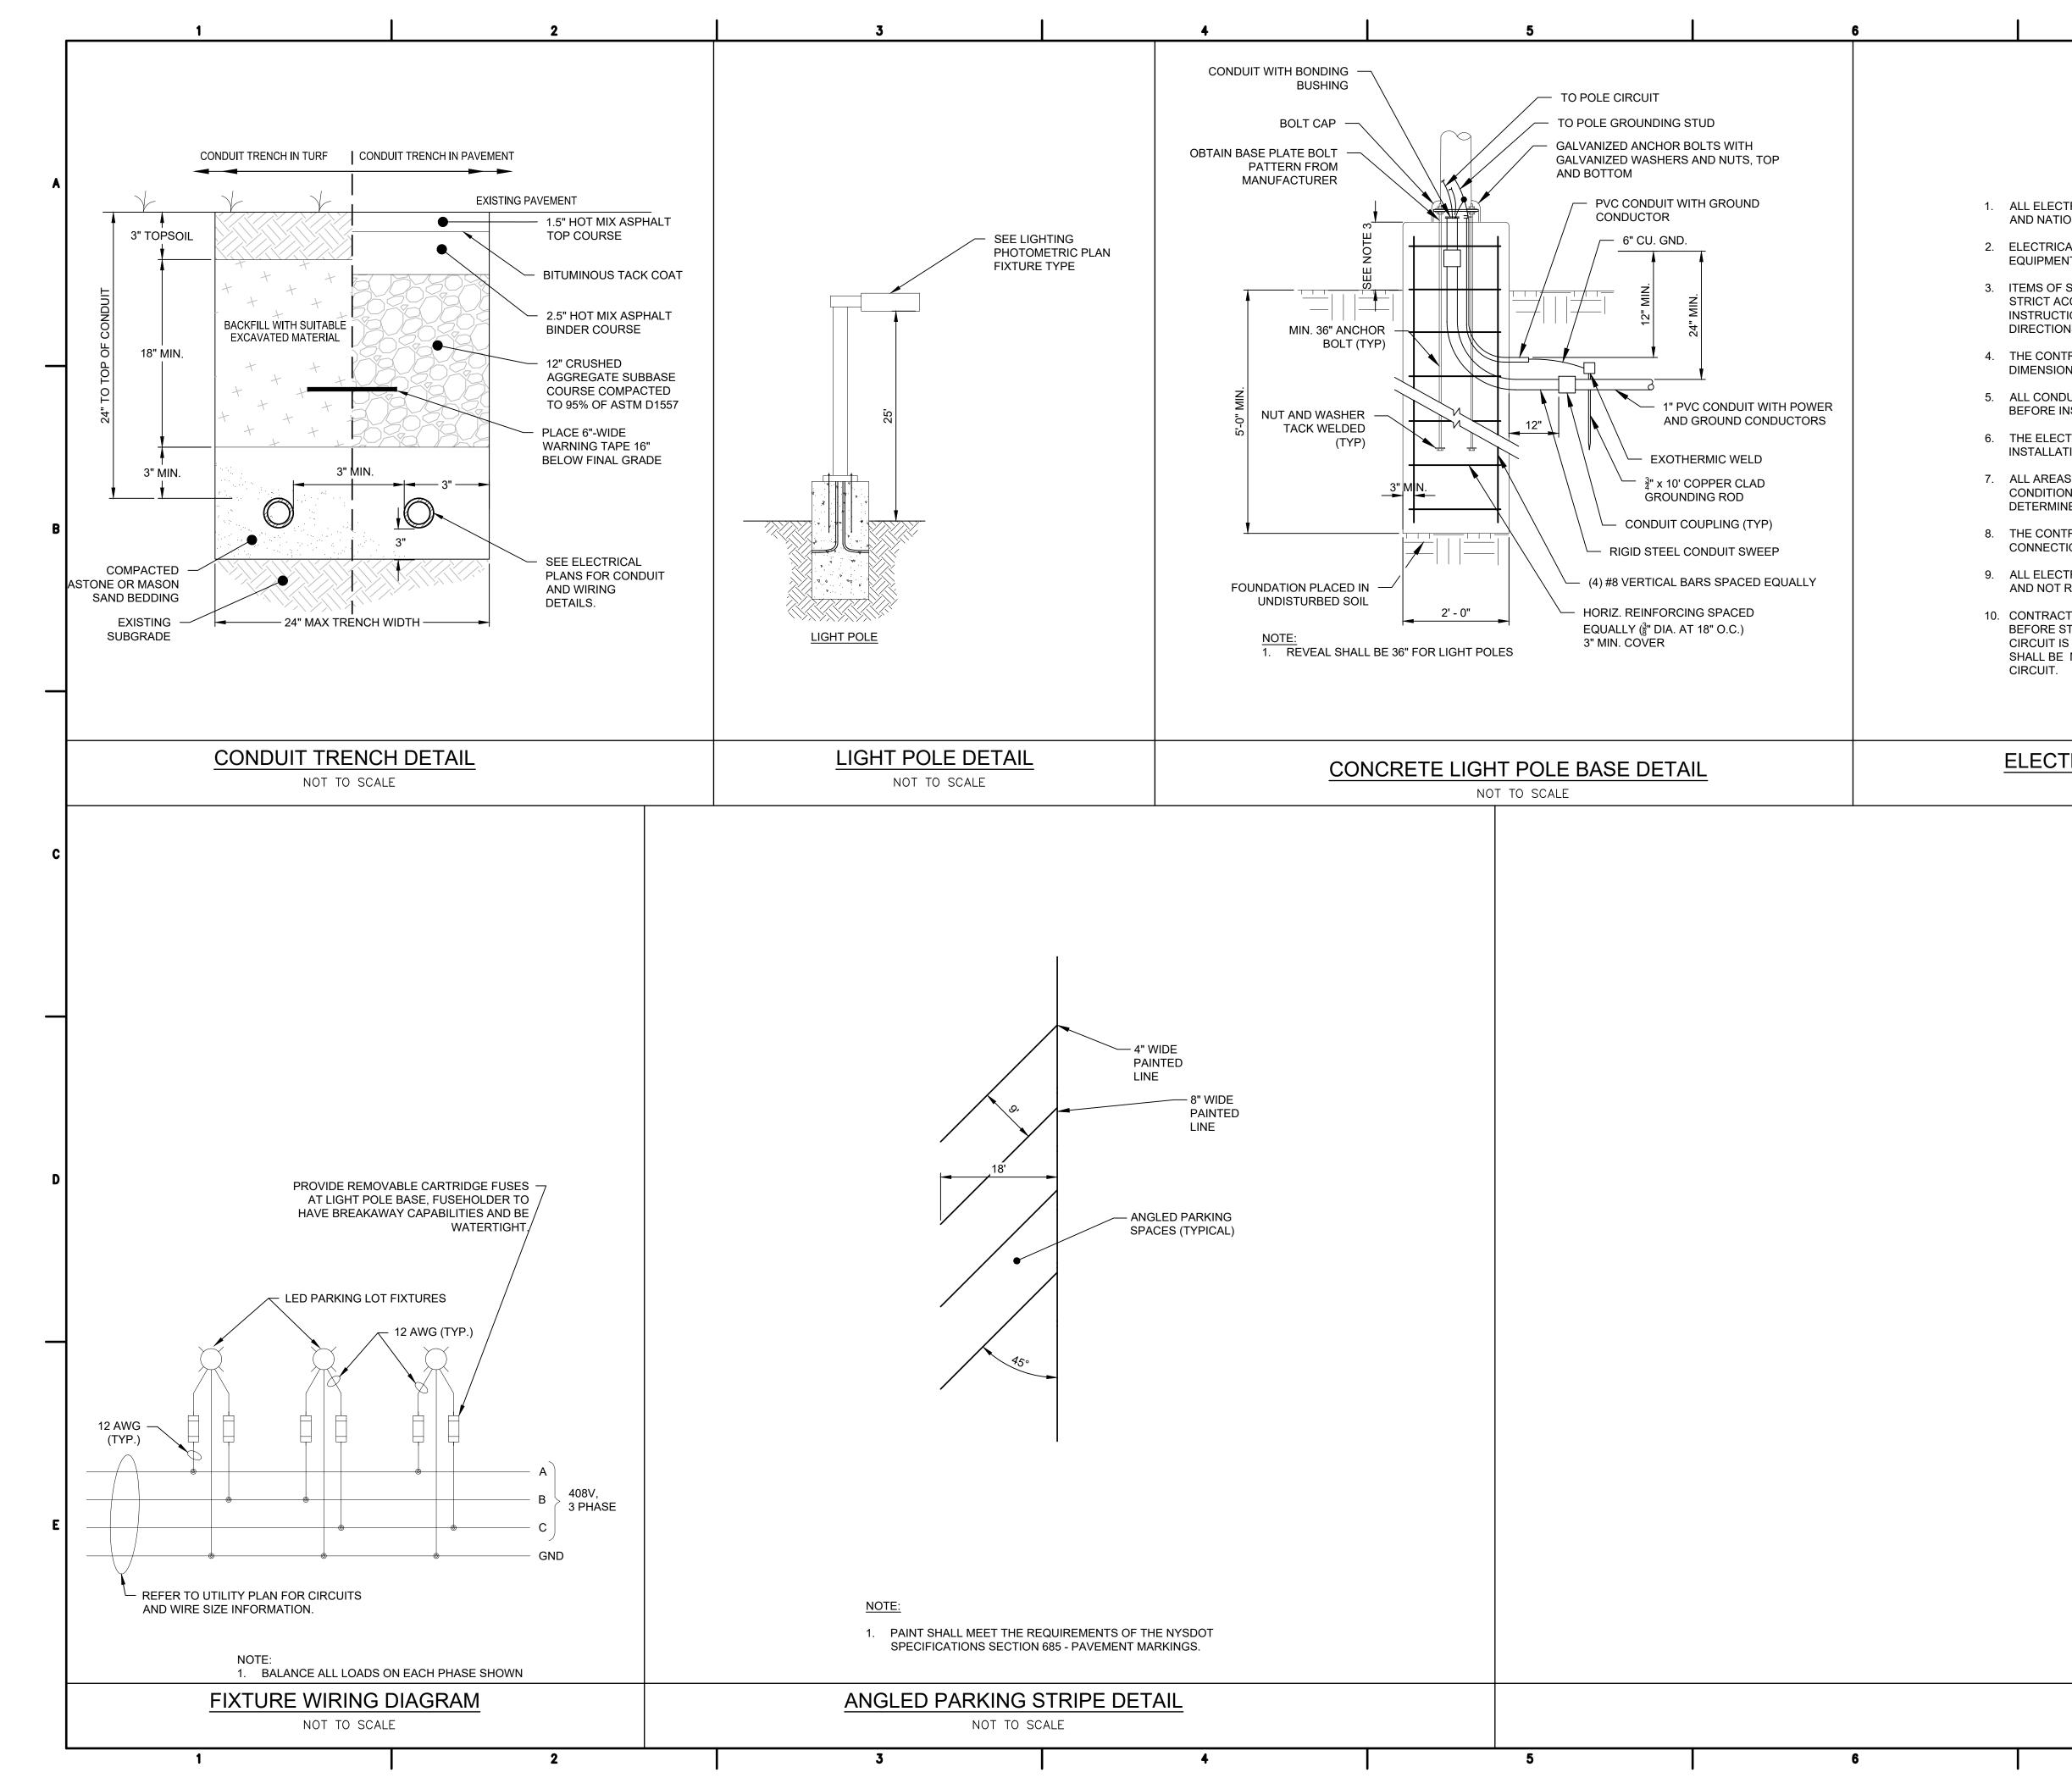
COMPOST SHALL BE AGED, FROM PLANT DERIVED MATERIALS, FREE OF VIABLE WEED SEEDS, HAVE NO VISIBLE FREE WATER OR DUST PRODUCED WHEN HANDLING, PASS THROUGH A HALF INCH SCREEN AND HAVE A PH SUITABLE TO GROW DESIRED

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	McFarland Johnson Engineers, Planning & Construction Administration 15 FISHERS ROAD; SUITE 200 PITTSFORD, NEW YORK 14534 P:585-905-0970 F:585-905-0882
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NT MANUFACTURER. SPECIFIC MANUFACTURER'S SHALL BE INSTALLED IN CCORDANCE WITH MANUFACTURER'S PRINTED	PROJECT MILESTONE FINAL PLANS
IONS AND/OR MANUFACTURER'S REPRESENTATIVE'S NS. TRACTOR SHALL FIELD VERIFY ALL LOCATIONS AND	NO. DATE DESCRIPTION
NS SHOWN ON THE DRAWINGS. DUIT AND WIRING SCHEDULES SHALL BE VERIFIED NSTALLATION.	
TRICAL CONTRACTOR SHALL COORDINATE THE TION OF ALL EQUIPMENT WITH OTHER CONTRACTORS.	RT T
S DISTURBED BY WORK SHALL BE RESTORED TO A N EQUAL TO OR BETTER THAN ORIGINAL AS IED BY THE ENGINEER.	AIRPORI EVARD NS
RACTOR SHALL PROVIDE RACEWAYS, WIRING, AND IONS FOR ALL CONTROL CIRCUITS AND INTERLOCKS.	
TRICAL CONDUIT AND CONDUCTORS DISCONNECTED REUSED SHALL BE REMOVED.	BOU 13212 PANS
TOR SHALL FIELD VERIFY ALL EXISTING CONDITIONS TARTING WORK. IF ONLY A PORTION OF AN EXISTING BEING REMOVED FOR DEMOLITION, CONTINUITY MAINTAINED TO THE REST OF THE REMAINING	OCK INTERNATIONA COCK INTERNATIONA EILEEN COLLINS BOU JSE, NEW YORK 1321 ARKING LOT EXPANS LOT #3 DESIGN
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